
	File # 7-B-21	-VA				
	FTALILIA	ADDEALS ADDI ICATION				
CITY OF KNOXVILLE BOARD C	OF ZONING	APPEALS APPLICATION				
Click on Meeting Schedule, Deadlines and Fees for informatic	on on submitting an	application to be heard at a monthly Board meeting.				
	APPLICANT IS:					
APPLICANT INFORMATION Name Michael Yovino	Owner	New Structure				
Street Address 151 TWIN Coves Dr	Contractor	Modification of Existing Structure				
	Tenant	Off Street Parking				
City, State, Zip Lenoir City, TN 37772 Phone Number 865-368-2869	Other D	Signage				
Email hometek.michael@gmail.com		Other				
Email hometek.michael@gmail.com	A REQUEST FOR					
Zoning Variance (Building Permit Denied)	Extensi	on of Non-Conforming Use/or Structure				
Appeal of Administrative Official's Decision		terpretation				
PROPER	TY INFORMATIC					
Street Address 7016 Yorkshire Drive		City, State, Zip Knoxville, TN 37909				
See KGIS.org for Parcel # 106NC003		and Zoning District RN-1				
City of Knoxville Zoning Ordinance Article 7, Section 2	ICE REQUIREMEN	115				
The City of Knoxville Board of Zoning Appeals shall have the power and authority to grant variances from terms of this ordinance according to the procedure and under the restrictions set out in this section. The purpose of the variance is to modify the strict application of the specific requirements of this ordinance in the case of exceptionally irregular, narrow, shallow or steep lots, or other exceptional physical conditions, whereby such strict application would result in practical difficulty or unnecessary hardship which would deprive an owner of the reasonable use of his land. The variance shall be used only where necessary to overcome some obstacle which is preventing an owner from using his property as the zoning ordinance intended.						
DESCRI	PTION OF APPE	AL				
Describe your project and why you need variances.						
We are proposing to demo an existing one car garage that was not originally built to best practices of construction (stud on asphalt with no apparent footers) and that cannot accommodate clients vehicle size (Ford F-150 truck), and replace with a slightly bigger and Building Code compliant unconditioned one car garage.						
The existing garage has an exterior dimension of 19'-3" depth from existing house towards front yard, with a width of 11'-6". The proposed garage has an exterior depth of 21'-9" towards front yard with 14'-2 1/2" width.						
City Zoning denied Permit, citing that the garage encroached on a 37'-0" front yard setback based on the average blockface calculations for RN-1 Zone relative to the clients property location. Architectural and Surveyor review notes this setback expands beyond the existing garage, and would reduce the allowable new garage depth to 15'-9 1/4" (not adequate for residential vehicle). Also, a side yard gas easement restricts reconfiguration of garage and garage access. Variance is sought to allow adequate garage.						
Describe hardship conditions that apply to this variance.						
Current front property setback does not allow for adequate one car garage to be rebuilt, as noted above. Gas easement at side yard restricts modified configuration of garage and drive access. Relocating garage on the property is not feasible.						
APPLICA	NT AUTHORIZA	TION				


I hereby certify that I am the authorized applicant, representing ALL property owners involved in this request and that all owners have been notified of this request in writing.

APPLICANT'S SIGNATURE


DATE 6/9/21


			File #				
	CITY OF KNOXVILLE BOARD OF ZONING APPEALS APPLICATION						
Section OF	KNOXVILLE	BOARD	OF ZONING APPEALS APPLICATION				
******OFFICE USE ONLY*****							
Is a plat required?							
VARIANCE REQUEST(S) WITH ORDINANCE CITATION(S):							
		PROJECT I	NFORMATION				
Date Filed			Fee Amount				
Council District PLANS REVIEWER			BZA Meeting Date DATE				

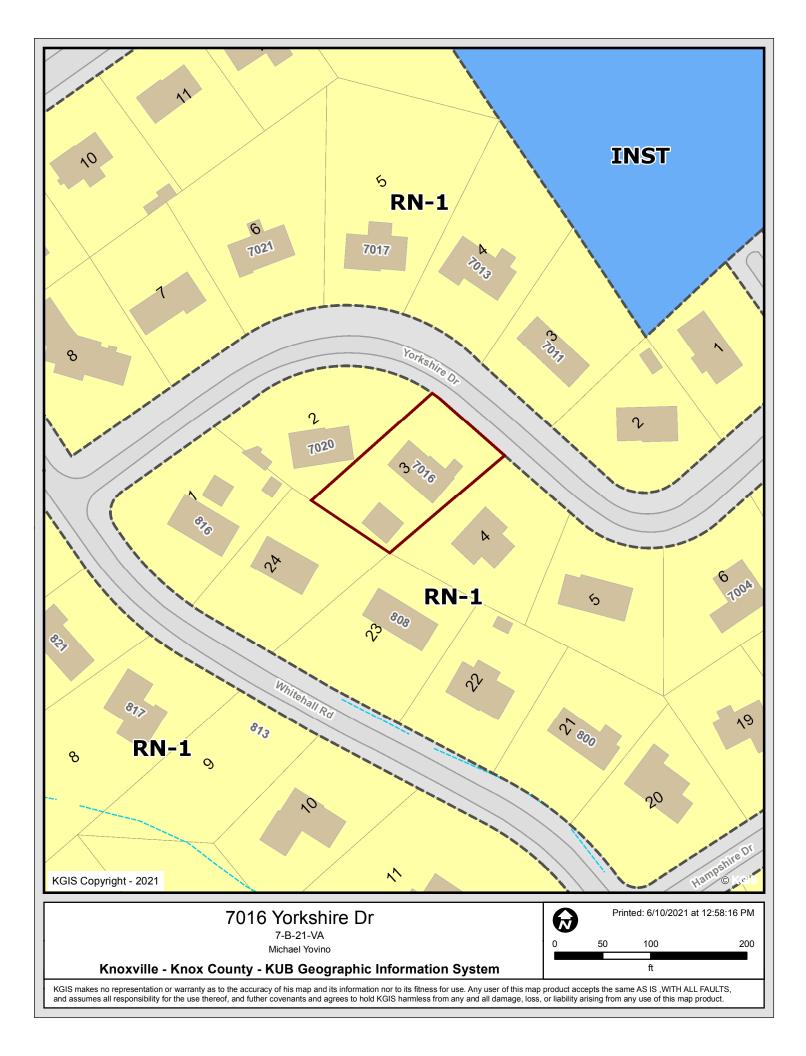


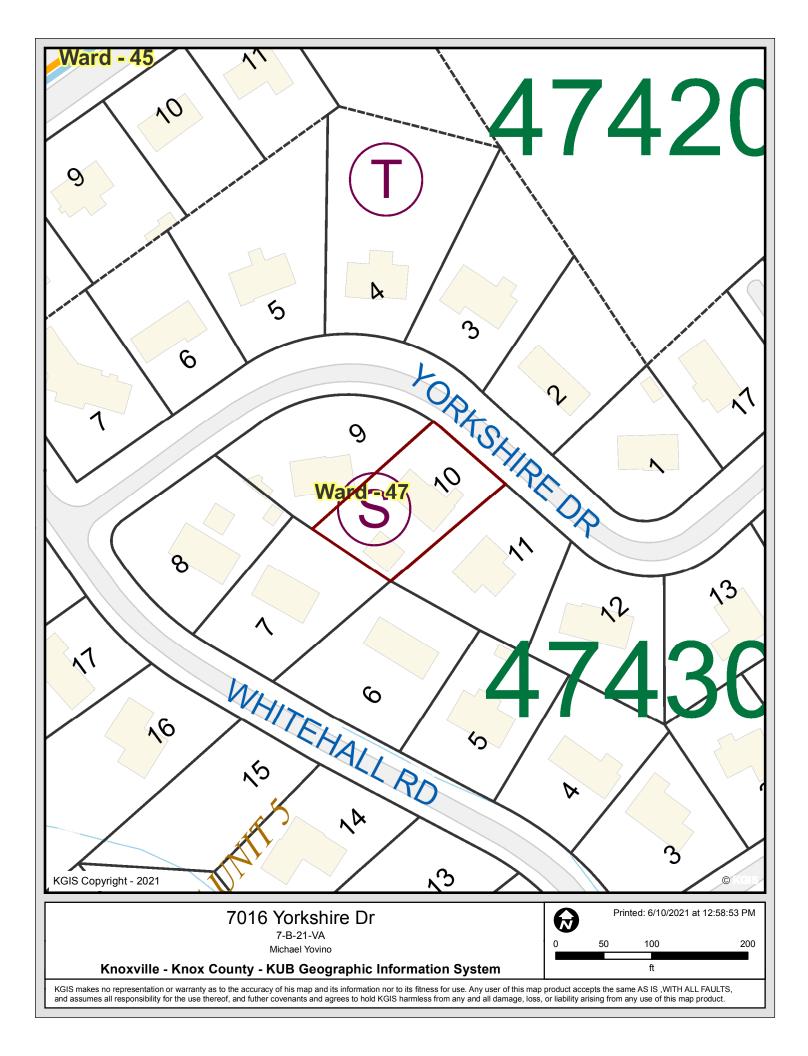



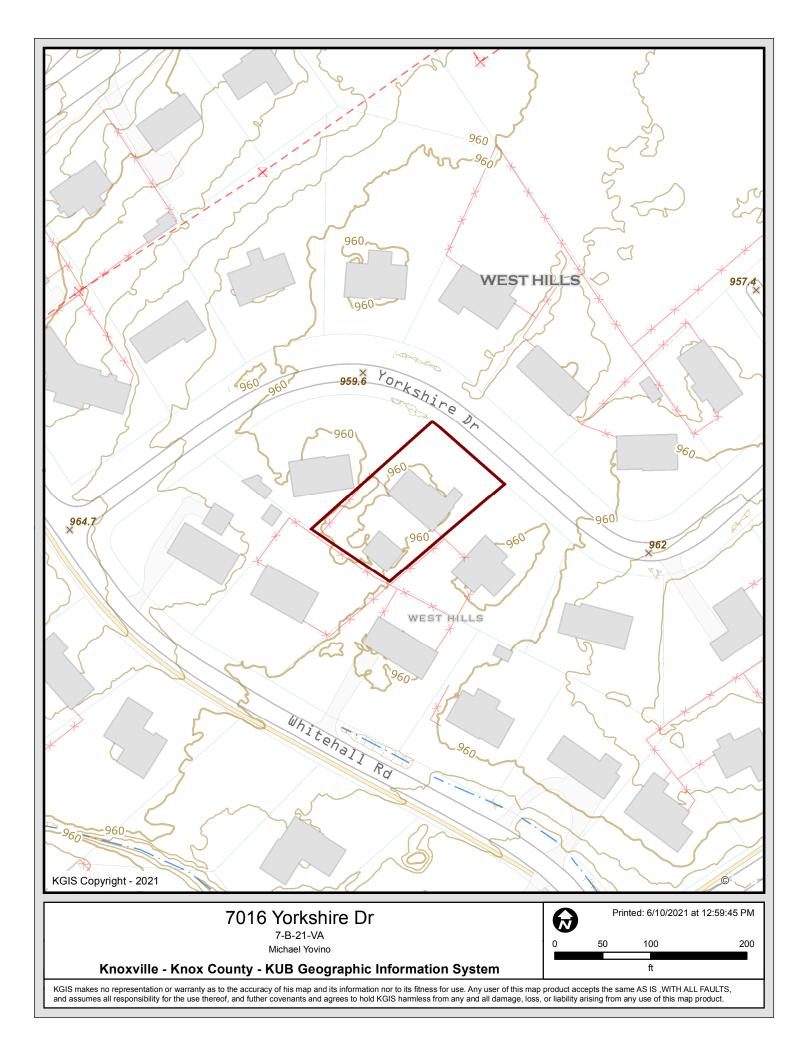

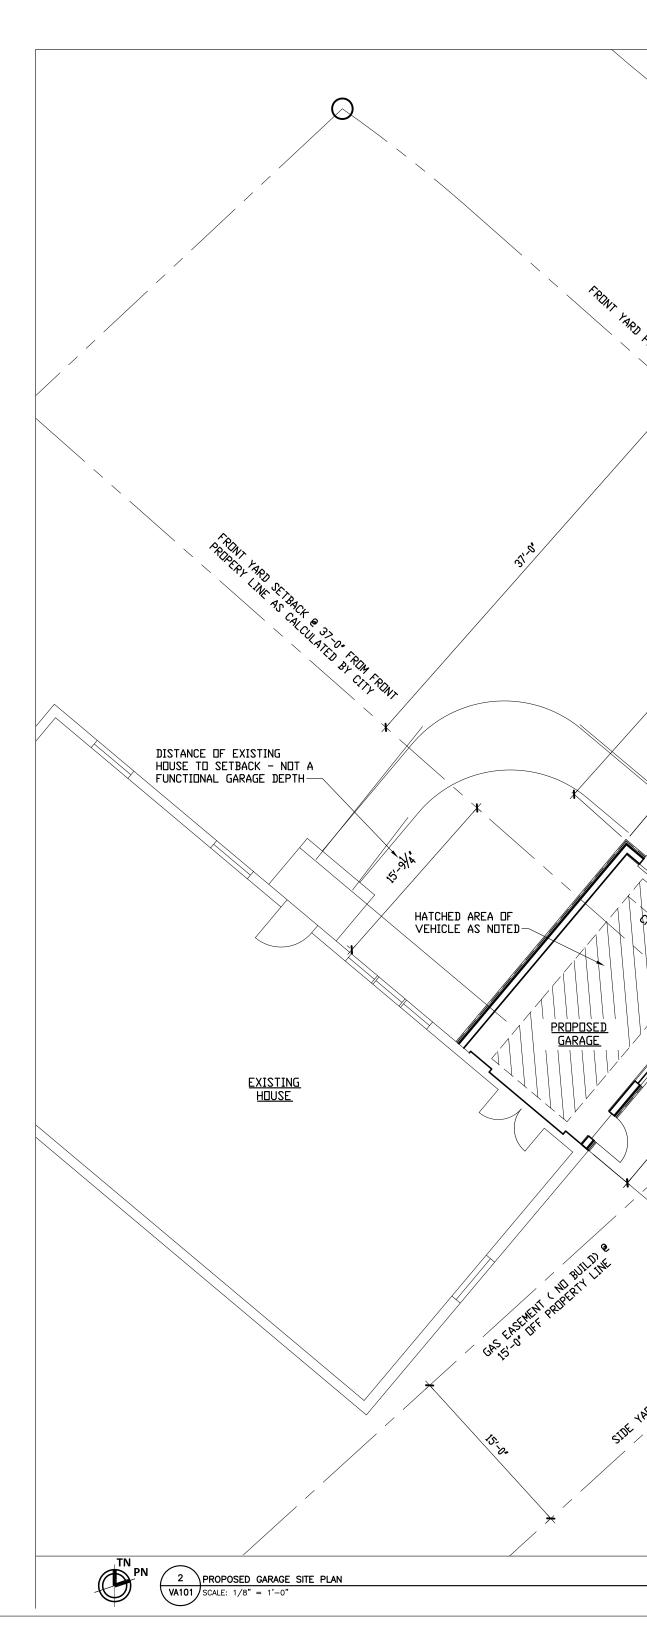

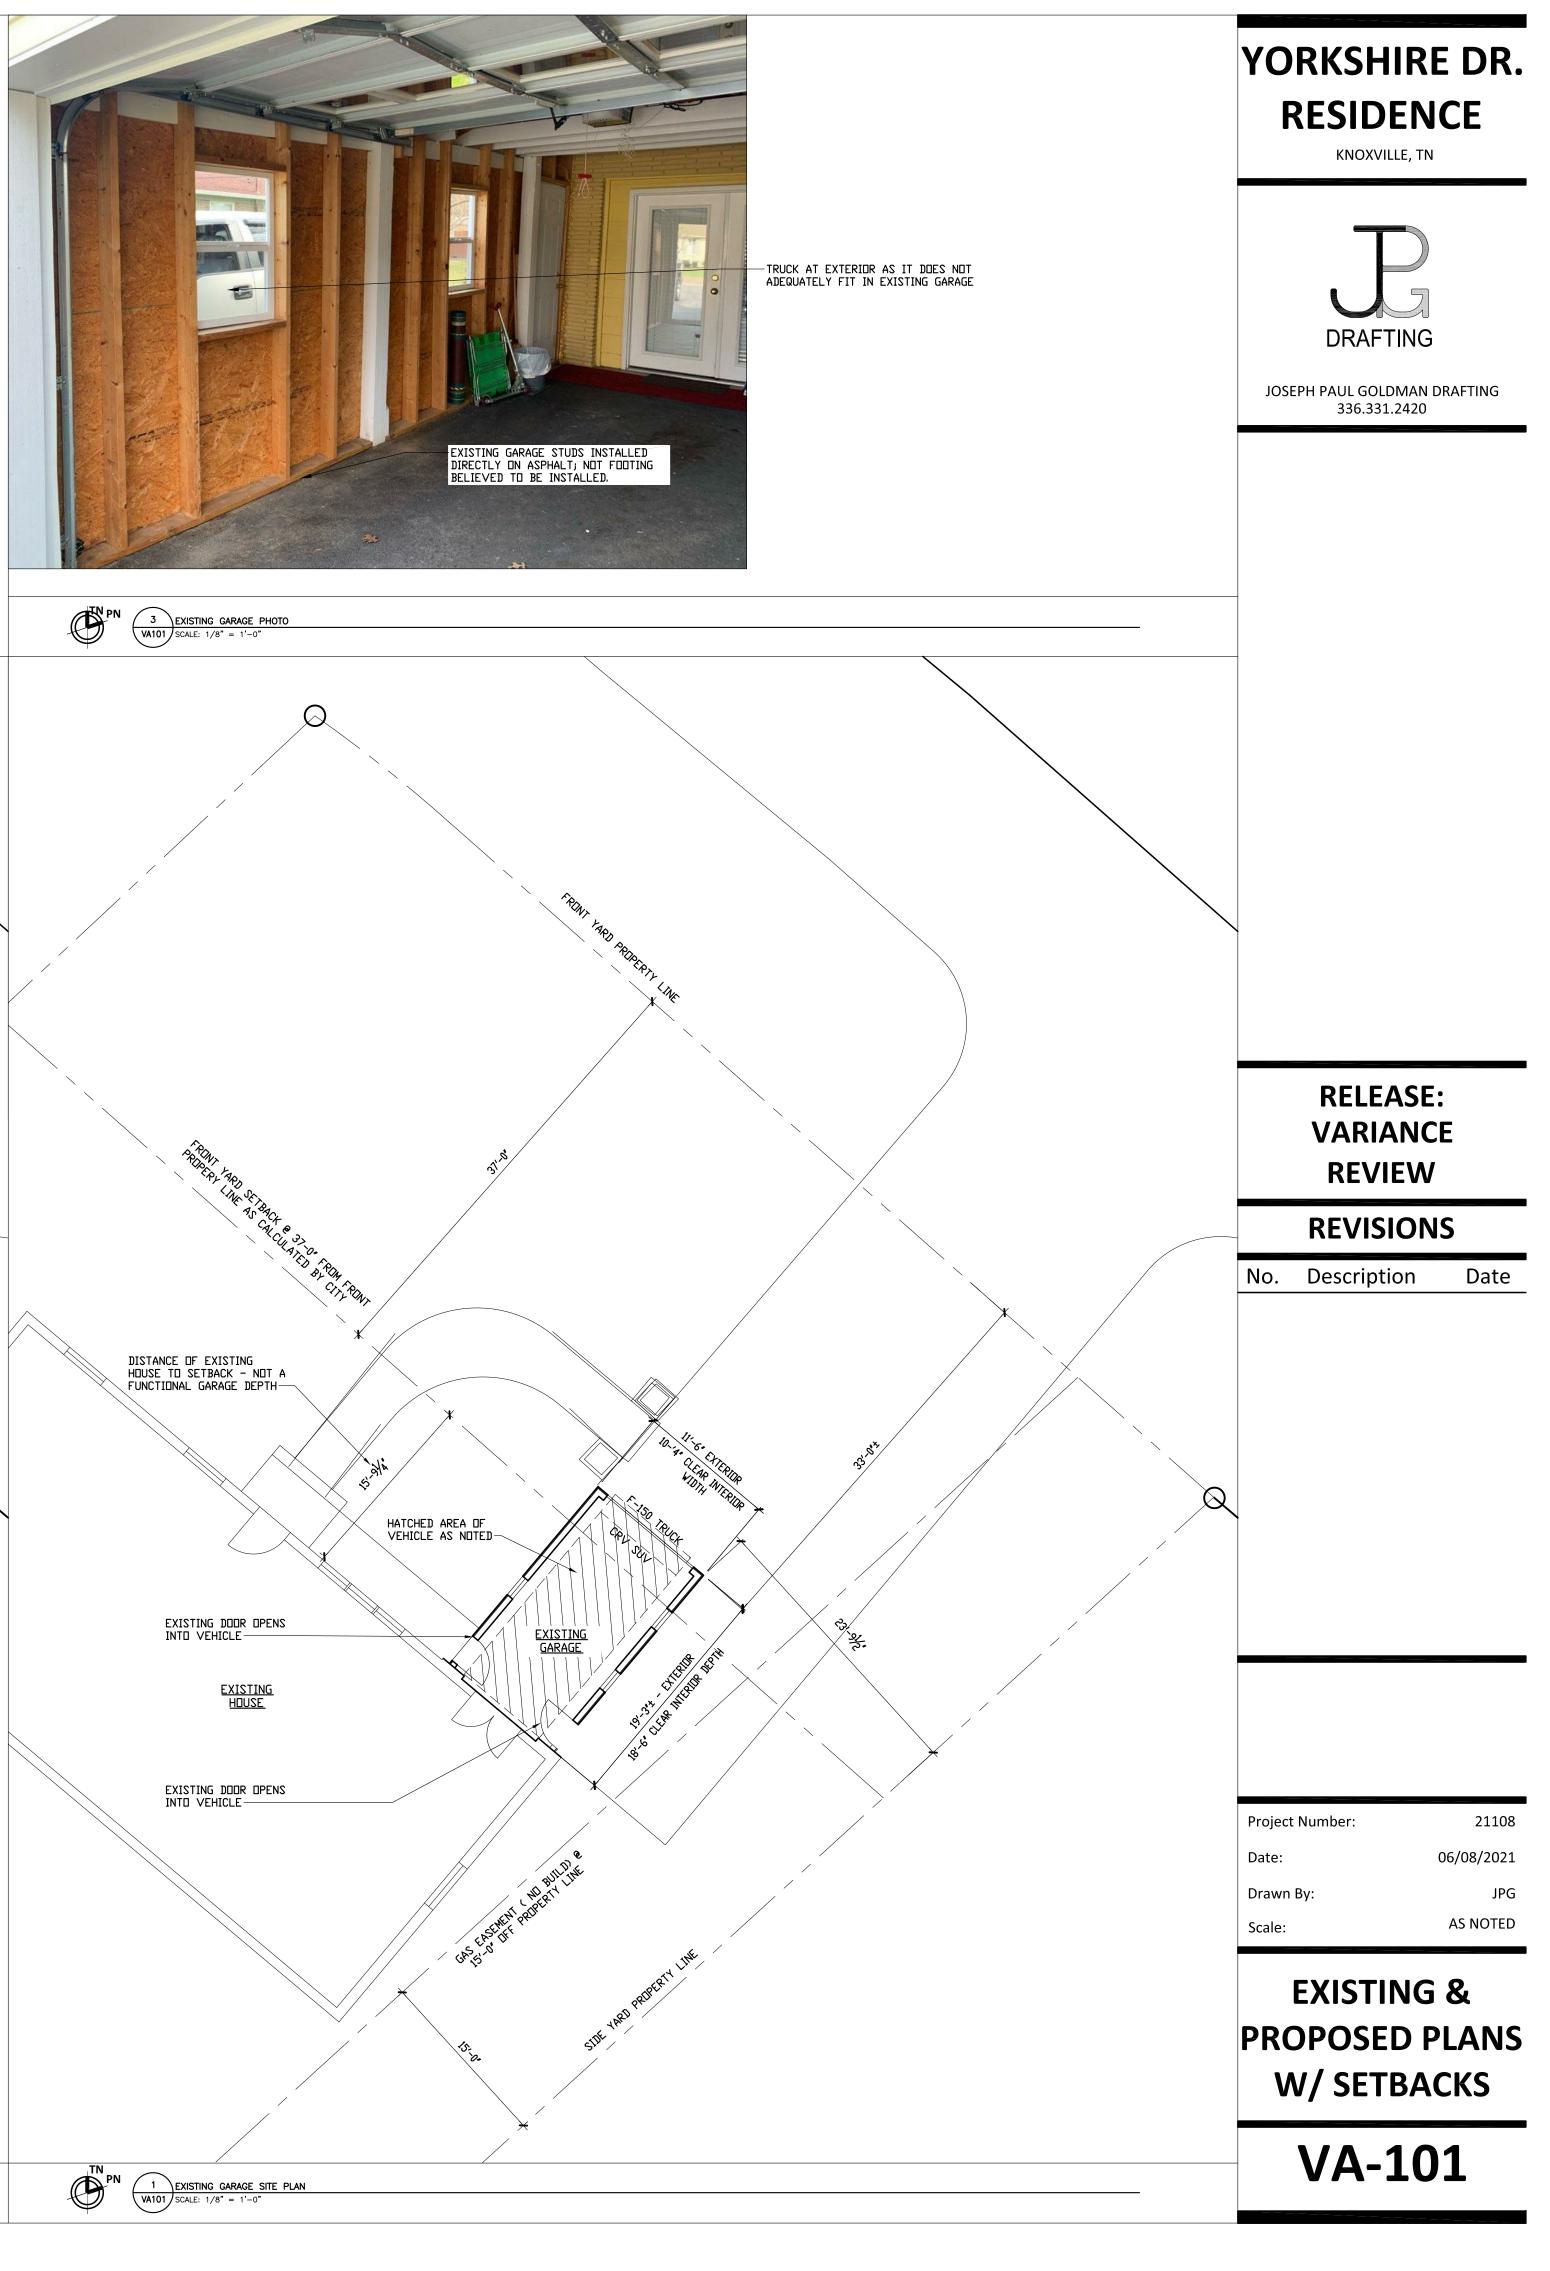



## A NEW UNCONDITIONED GARAGE FOR THE: **YORKSHIRE DRIVE RESIDENCE** 7016 YORKSHIRE DRIVE KNOXVILLE, TN 37909

## **GENERAL NOTES**


- 1.1 <u>Codes:</u> All work must comply with all Codes & Regulations - Federal, State, & Local - of the jurisdiction in which the project is constructed. Codes govern over Drawings.
- 1.2 Minimum Standards: In the absence of more stringent Codes, Regulations, or specifications on the Drawings, all applicable construction shall conform to the latest editions of International Residential Code (IRC) & City Ordinances and Amendments.
- Site in All indicated survey materials are for general information only.
- 1.4 Inspections: The Contractor shall schedule, pay for, & obtain all required inspections. The Contractor shall obtain a Certificate of Occupancy as required by the local regulations.
- 1.5 <u>Work Rules:</u> The Contractor shall be responsible for all applicable regulations & shall verify & comply with all local regulations governing construction.
- 1.6 <u>Utilities:</u> The Contractor shall coordinate, contract, & pay for the installation of & connection to all public utilities.
- 1.7 <u>Licensed Subcontractors:</u> All electrical, HVAC, & plumbing work shall be performed by licensed contractors, and in accordance with all governing codes & regulations.
- 1.8 <u>Protection:</u> The Contractor shall be responsible for the protection of the building & property through completion of the project.
- 1.9 <u>Dimensions:</u> Do not scale drawings. Verify any missing dimensions with Designer. The Contractor shall coordinate, verify, & be responsible for all field dimensions related to the work & shall provide all required dimensions to Subcontractors.
- 1.10 <u>Cutting:</u> Unless shown on Designers drawings, no beam, columns, or structural non-repetative structural elements shall be cut without prior written approval of licensed Structural Engineer. Repetitive structural members (studs, joists, etc.) shall be cut only as allowed by the manufacturer or governing codes. & proper reinforcement must be provided. Reinforcement method shall be approved in advance by the Structural Engineer. Reinforcement & patching shall be made at the expense of the Contractor.
- 1.11 <u>Patching:</u> The Contractor shall be responsible for all patching required during progress of the work. Repaired materials & joints must be straight, plumb, & smooth & shall exhibit no evidence of repair.
- 1.12 <u>Non-Exclusions:</u> Any Work not described on the Drawings which is standard practice in quality construction & which is necessary for proper & complete construction shall be furnished as though fully shown & described. The Contractor shall be responsible for providing a complete & finished job.
- 1.13 <u>Shoring:</u> The Contractor shall be responsible for all required shoring, temporary supports, & temporary bracing.
- 2.1 <u>Finish Grade:</u> Slope grade away from building on all sides. 3.1 <u>Concrete:</u> Refer to Engineer drawings for steel reinforcement
- requirements. Contractor to review and verify all steel reinforcement meets minimum Building Code requirements.
- 4.1 <u>Masonry:</u> Refer to local codes for masonry reinforcement requirements.
- 6.1 <u>Framing at M/E/P Fixtures & Devices:</u> Coordinate framing layout with all Mechanical, Electrical, & Plumbing fixtures. Refer to Floor Plans, Framing Plans, Electrical/Reflected Ceiling Plans, & Building Sections for fixture & device locations.
- 6.2 <u>Support Blocking:</u> Provide solid 2x blocking in walls & ceilings for stair rail brackets, bath accessories, suspended ceiling fixtures, & other installed items requiring structural support or bracing.

- Firestopping: Provide approved firestopping & draftstopping as required by the Tennessee State Building Code or by local codes, whichever are more stringent.
- Flashing: Provide flashing wherever required in the construction, whether or not indicated on the drawings. See specifications or drawings for flashing materials & other additional requirements.
- 15.1 <u>Plumbing</u>:
- All work to meet national, state, & local codes. - Plumbing Contractor shall be responsible to file for all permits & obtain all inspections at no additional expense to the Owner. - Coordinate all plumbing lines & fixtures with concrete, masonry, framing, & finish requirements.

15.2 <u>Mechanical:</u>


- All work to meet national, state, & local codes.
   Mechanical Contractor shall be responsible to file for all permits & obtain all inspections at no additional
- expense to the Owner. - Coordinate all mechanical equipment, ducts, & fixtures with concrete, masonry, framing, & finish requirements. Refer to both Designerural Drawings.
- U.O.N., HVAC registers located above doors & windows & below windows shall be centered on these openings. Coordinate distance off wall with Owner.
- Where implied, but not dimensioned, center registers on walls/ceilings. - Contractor shall not cut or notch structural post or
- beam without prior approval of Structural Engineer. 16.1 <u>Electrical Service Requirements:</u>
- All work to meet national, state, & local codes. - Electrical Contractor shall be responsible to file for all permits & obtain all inspections at no additional expense to the Owner. - Where implied, but not specified or dimensioned, center
- fixtures on walls & ceilings.

SYMBOL LEG					<b>NS</b>	<b>PROJECT LOCA</b>
11 31100000000	GEND	ABBRE	VIATIONS			rook
$\bigcirc$	ELEVATION DRAWING	A&B	ABOVE & BELOW	MTL	METAL	I A A A A A A A A A A A A A A A A A A A
	BUILDING/WALL SECTION	ABV ACRF	ABOVE ACCURUFF	N/A NSF	NOT APPLICABLE NET SQUARE FEET	BILd
	PLAN/SECTION DETAIL	ACT ADJ	ACOUSTIC TILE ADJACENT	N.T.S. OCC	NOT TO SCALE OCCUPANT/OCCUPANCY	
	PARTITION DETAIL	ASF	ABOVE SUBFLOOR	o/c	ON CENTER	
	ELEVATION HEIGHT	AFF AMG	ABOVE FINISH FLOOR ABOVE MEAN GRADE	PA PB	POST ABOVE POST BELOW	oike
X'-XX"	CEILING HEIGHT (A.F.F.)	BB BC	BACKBAND BRICK COURSE	PERP PL	PERPENDICULAR PLATE	MiddlebrookPike
	WINDOW NUMBER	B.O. BD	BOTTOM OF BOARD	PLAM PLMB	PLASTIC LAMINATE PLUMBING	lebro
	DOOR NUMBER	ВМ	BENCHMARK	PLYISO	POLYISOCYANURATE	Mido
	CASED OPENING NUMBER	B/S B-S	BACK SPLASH BAND SAWN	PLYPROP PLYSTY	POLYPROPYLENE POLYSTYRENE	
		BTWN CAB	BETWEEN CABINET	PLYUR PLYWD	POLYURETHANE PLYWOOD	PRDJECT
	OPEN SHAFT/DUCT	CC	CMU COURSE	PNT	PAINT(ED)	SITE
	REVISION NUMBER	CER C-C	CERAMIC CLOSED—CELL	POLY PRC	POLYETHYLENE PORCELAIN	
	HOSE BIBB	C-L CLG	CENTERLINE CEILING	P-T R+Q	PRESSURE–TREATED (CCA) RIFT & QUARTERED	York
MATERIAL LE	EGEND	CLR/CL	CLEAR	RFT	RAFTER	
	CONCRETE	CMT COL	CEMENT COLUMN	RCP REF.	REFLECTED CLG PLAN REFRIGERATOR	
	CONCRETE MASONRY	CP CWP	CLEAR PINE CLEAR WHITE PINE	REINF	REINFORCED RADIO FREQUENCY	
	BRICK MASONRY	CONC CONT	CONCRETE CONTINUOUS	RFST R.O.	REFER TO STRUCTURAL ROUGH OPENING	
	STONE	CUST	CUSTOM	R-S	ROUGH SAWN	
	METAL	DF D.W.	DOUGLAS FIR DISH WASHER	SIM SAMF	SIMILAR SELF—ADHERED	
	WOOD FRAMING BLOCKING	EQ E/W	EQUAL EACH WAY	SATB	MEMBRANE FLASHING SPRAY APPLIED THERMAL	
	FINISH WOOD	EXT	EXTERIOR		BARRIER	X Pepr
	CELLULAR PVC	FB FAT	FREEBOARD USG FIBEROCK AQUA–TOUGH	SFTI	SPRAY FOAM THERMAL INSULATION	Hampshire D.
	BATT INSULATION	FG FND	FIBERGLASS FOUNDATION	SS STD	STAINLESS STEEL STANDARD	Hamit
	RIGID INSULATION	F.O. FRP	FINISH OPENING FIBERGLASS-REINFORCED	STL	STEEL STAIN / STAINLESS	Wes
	URETHANE FOAM INSULATION		PLASTIC (PANEL)	STR	STRUCTURAL	
		FRT FTG	FIRE—RETARDANT TREATED FOOTING	SUPCD SYP	SUPERSEDE(S) SOUTHERN YELLOW PINE	
		G.L.B. GSF	GLULAM BEAM GROSS SQUARE FEET	T&B T&G	TOP & BOTTOM TOUNGE & GROOVE	
		GWB	GYPSUM WALL BOARD	T.B.D.	TO BE DETERMINED	
		H-B HDG	HDPE_BUTYL HOT DIP_GALVANIZED (G185)	T.O. TYP	TOP OF TYPICAL	
		HDPE HM	HIGH DENSITY POLYETHYLENE WELDED HOLLOW MTL FRAME	UON UL	UNLESS OTHERWISE NOTED	BUILDING AF
		HORZ	HORIZONTAL		UNDERWRITERS LABORATORIES	
		H.P. INSUL	HIGH POINT INSULATION	VAR VER	VARIES VERIFY	GROSS BUILDING AREAS: MEASURED TO INSIDE FACE OF F
			INTERIOR INTERMEDIATE	VIF VERT	VERIFY IN FIELD VERTICAL	DESCRIPTION OF NEW CONDITIONED & UNCONDITION
		JNT	JOINT	VCT VSB	VINYL COMPOSITION TILE VINYL SANITARY BASE	FLOOR AREA HEATED FLOOR(SF) NON HEATED
DIMENSION L	LEGEND DIMENSION NOTES	JST K-F	JOIST KRAFT—FACED	VGV	V-GROOVE	NEW GARAGE NA 31
A 31/2"	1. U.O.N. ALL DIMENSIONS ARE TO FACE OR	KD KD-AT	KILN DRIED KD AFTER TREATMENT	VP W/	VENEER PLASTER WITH	
B 51/2"	CENTERLINE OF STRUCTURE (WOOD FRAMING, CONCRETE, MASONRY, OR STEEL).	KDHM L-C	KNOCK DOWN MTL FRM LEAD–COATED	WD WH	WOOD WATER HEATER	
	2. SEE DIMENSION LEGEND FOR DIMENSION STRING ABBREVIATIONS.	LNL	LINOLEUM	W.O.	WHITE OAK	
	3. DIMENSIONAL REFERENCES IN NOTES THAT INCLUDE FEET (') AND OR INCH ('') SYMBOLS INDICATE ACTUAL DIMENSIONS.	L.P. MDF	LOW POINT MEDIUM DENSITY	WP WPM	WATERPROOF WATERPROOF MEMBRANE	
	4. DIMENSIONAL REFERENCES IN NOTES THAT DO NOT INCLUDE FEET OR INCH SYMBOLS	М.О.	FIBERBOARD MASONRY OPENING	WR	WATER RESISTANT	
	(SUCH AS 5/4 OR 2X) ARE NOMINAL DIMENSIONS.					

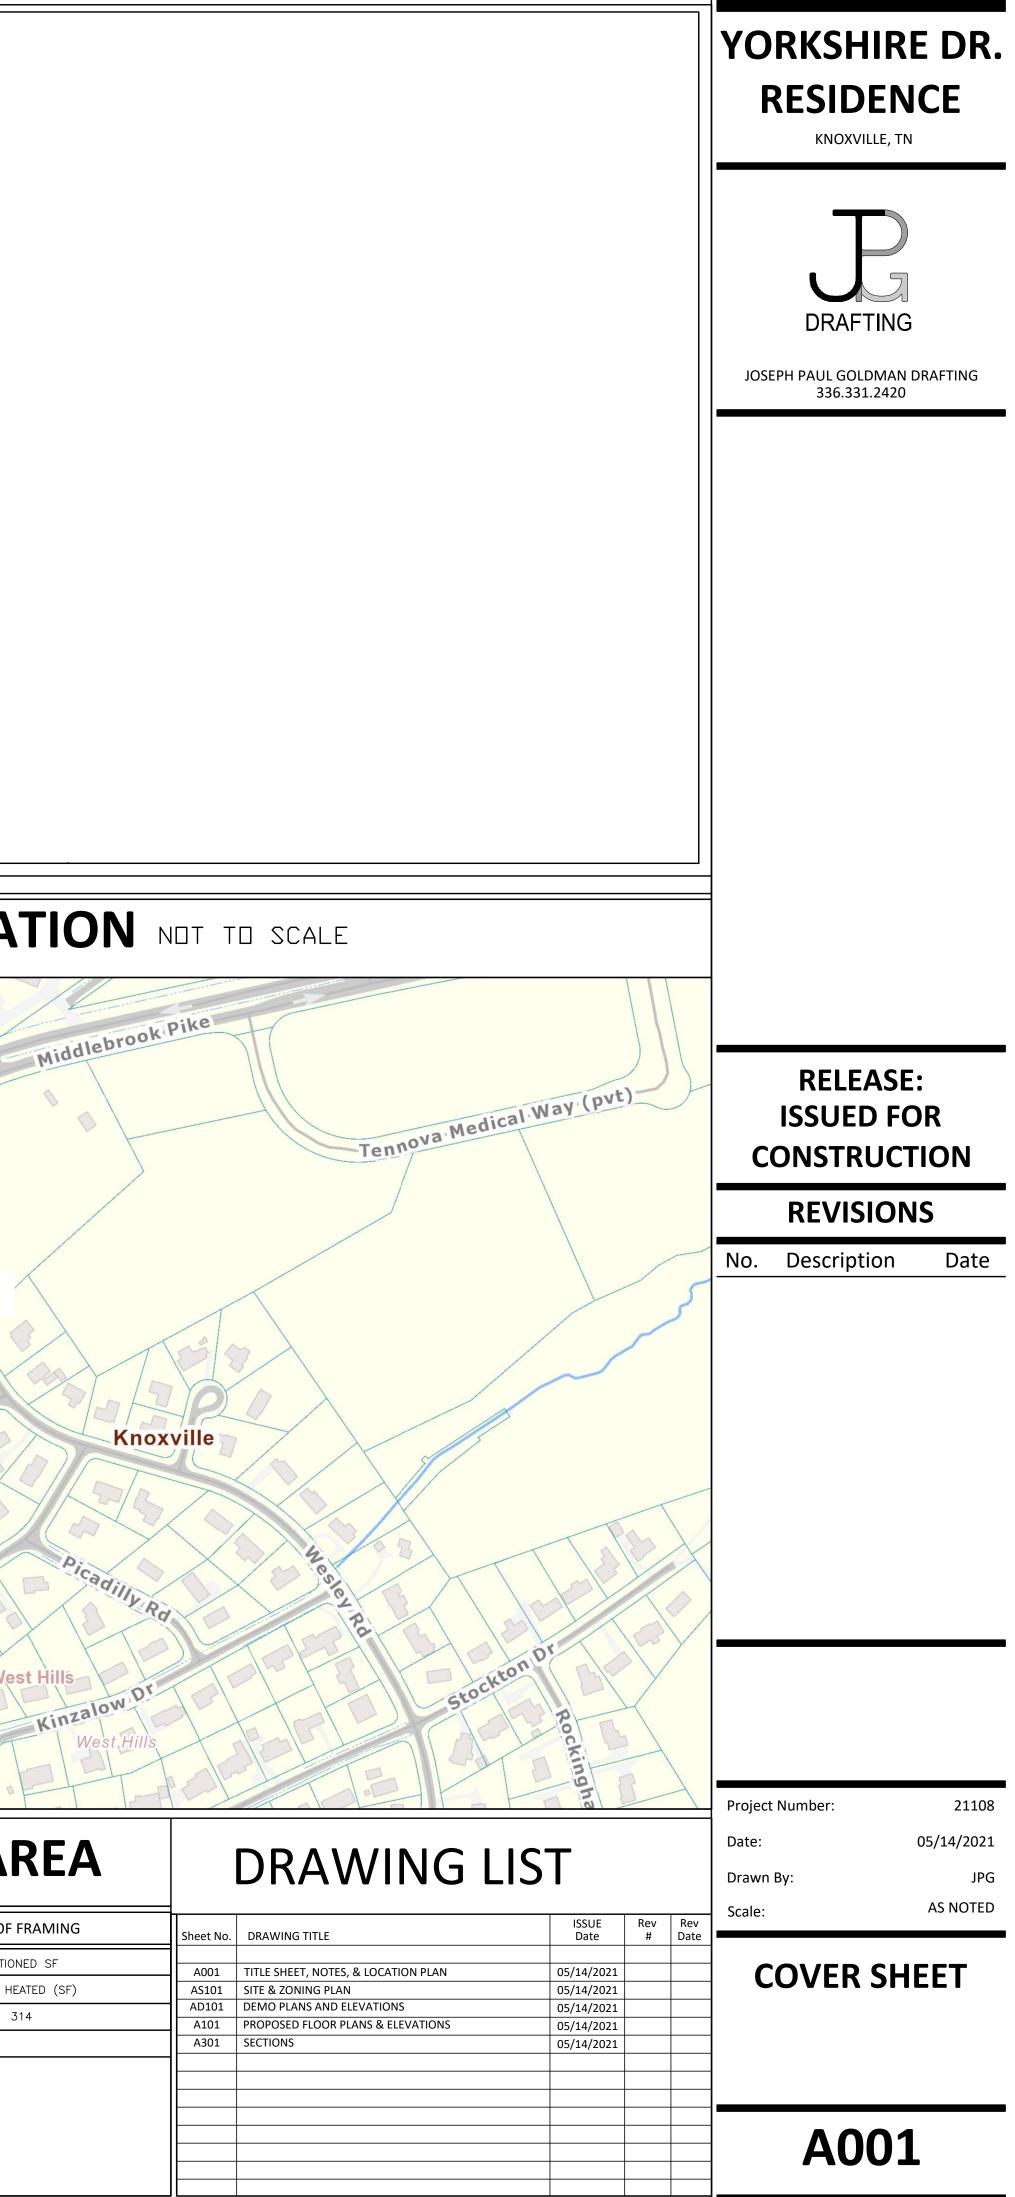






ZONING INFORMATION: (PER KGIS & KNOX COUNTY ZONING)	YORKSHIRE DR.
PARCEL ID: 106NC003	RESIDENCE
DISTRICT:	KNOXVILLE, TN
WARD: 47	
SUBDIVISION: WEST HILLS UNIT 5	
JURISDICTION: - COUNTY: KNOX COUNTY	
– CITY: KNOXVILLE	
ZONE: RN-1	
SETBACKS: - FRONT: 25'	DRAFTING
– SIDE: 8' MIN 20' COMBINED MIN – REAR: 25'	JOSEPH PAUL GOLDMAN DRAFTING
<ul> <li>SITE INFORMATION IS BASED ON CURRENT KGIS WEBSITE DATA &amp; IS BEING PROVIDED TO DEMONSTRATE BUILDING PERMIT &amp; ZONING CONFORMANCE ONLY. FINAL TOPOGRAPHY AND PROPERTY DATA TO BE VERIFIED BY CONTRACTOR AND SURVEYOR PRIOR TO</li> </ul>	336.331.2420
CONSTRUCTION. SITE PLAN & PROJECT ORIENTATION	
PN TN	
N: TRUE NORTH (PER SITE PLAN)	
PN: PROJECT NORTH (PROPOSED PLAN ORIENTATION)	
SITE PLAN LEGEND	
PROPERTY LINE	
SETBACK LINE	
TOPOGRAPHY	
x	
EXISTING BUILDINGS	
EXISTING DRIVEWAY TO BE RE-TOPPED	
NEW GARAGE - COORDINATE W/ BUILDING PLANS	
LOT COVERAGE AREA	RELEASE:
1. LOT AREA: 15,743 SF	ISSUED FOR
2. <u>HARDSCAPE</u> : TOTAL: 4,114 SF @ 26% 2.1. EXISTING DRIVE: 1,009 SF	
2.2. EXISTING STRUCTURES: 2,597 SF 2.3. EXISTING PORCH/WALKPATH: 194 SF	CONSTRUCTION
2.4. NEW GARAGE: 314 SF 3. <u>VEGETATIVE COVERAGE</u> : TOTAL 11,629 @ 74%	REVISIONS
······································	
	No. Description Date
	Project Number: 21108
	Date: 05/03/2021
	Drawn By: JPG
	Drawn By:JPGScale:AS NOTED

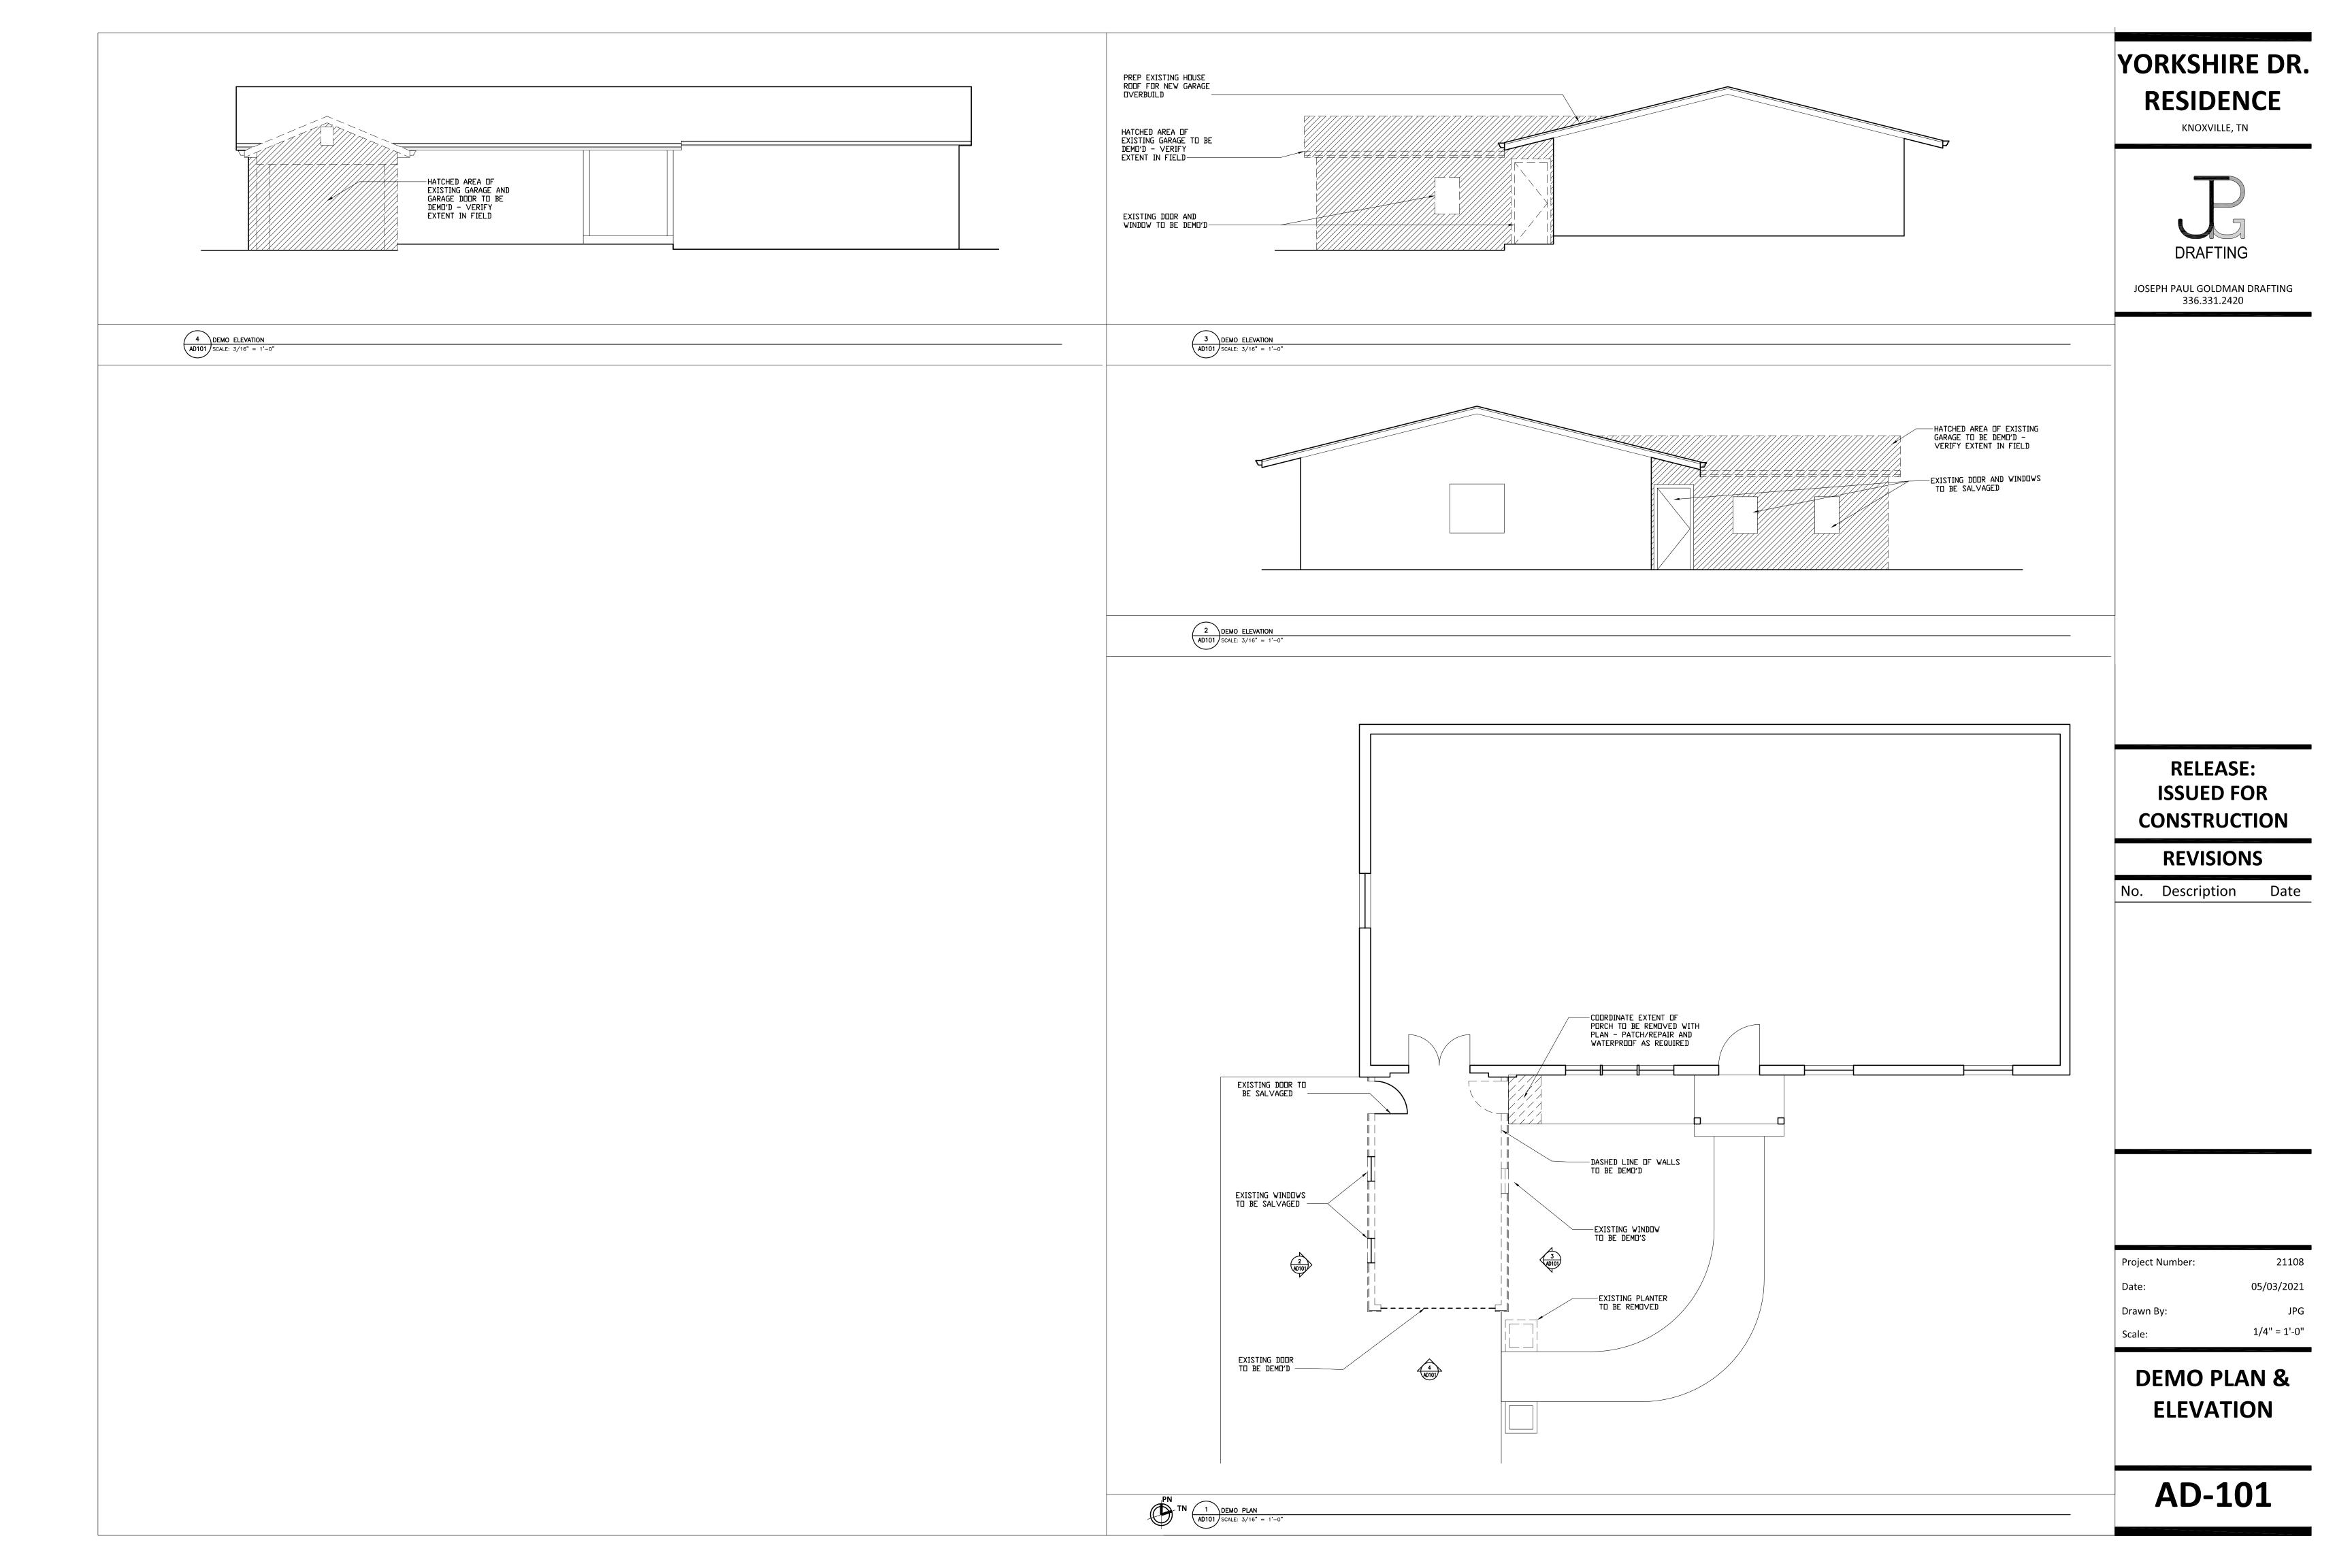


RDDF SHINGLES TO MATCH EXISTING HOUSE OVER #30 FELT, OVER 36" ICE & WATER SHIELD (TO BE APPLIED AT ALL EAVES, RIDGES, AND VALLEYS), OVER 1/2" OSB SHEATHING.————————————————————————————————————				
1X8 HARDIE RAKE BOARD - FINISH TO BE DETERMINED BY OWNER		-4-1	NEW DECORATIVE GABLED LOUVER - VERIFY WITH DWNER AND RODF	
NEW GUTTERS AND DOWNSPOUTS TO MATCH EXISTING - VERIFY FINAL LOCATION IN FIELD AND TERMINATE				
DNTD SPLASH BLOCK ABOVE GRADE	6'-0':			
- FINISH TO BE DETERMINED BY OWNER; TYP. @ OUTSIDE CORNERS				
HARDIE LAPBOARD SIDING W/ 8' EXPOSURE - FINISH TO BE DETERMINED BY OWNER. 2X4 HARDIE BASE TRIM WITH BEVELED TOP - FINISH TO BE DETERMINED BY OWNER				
2" STONE WATERTABLE - FINAL BY OWNER 2" VENEER STONE; INSTALL OVER 3/8" MORTAR BED & 3/8" SCRATCH COAT, LATH, & (2) LAYERS WEATHER RESISTIVE BARRIER OVER CMU OR PLYWOOD PER A301			<u>&gt;</u>	
& AS DIRECTED BY MANUFACTURER DASHED LINE OF FOUNDATION FOR REFERENCE - COORDINATE W/ SECTIONS				
AND FRAMING/FOUNDATION PLANS				
ELECTRICAL & REFLECTED CEILI			CONSTRUCTION GENERA	
DEDICATED OUTLET			1. ALL NEW INTERIOR FINISHES REQUIRED	D TO BE MODIFIED BY
▲ =1 🖌 =2 EXTERIOR FLOOD LIGHTS		DLTAGE	NEW BUILD-OUT TO MATCH EXISTING WITH OWNER.	
			2. ALL NEW EXTERIOR DOOR SLABS & W OWNER IN COORDINATION W/ CONTRAC HEAD, JAMB, AND SILL FLASHING PER	CTOR. INSTALL NEW
ELECTRICAL SCHEDULE NOTES:	RECEPTACLE N	IOTES:	MANUFACTURER RECOMMENDATIONS. AI CONDITIONED FROM UNCONDITIONED S	LL DOORS SEPARATING PACES SHALL BE PROV
1. COORDINATE FINAL LIGHTING SELECTION W/ OV	VNER	EPTACLES HORIZONTALLY 6" /ALL IN WOOD FRAMING.	APPROVED WEATHER SEALS & GASKET HAVE APPROVED THRESHOLDS AND	RAIN GUARD.
2. U.O.N, DIMENSIONS ARE TO FIXTURE & DEVICE CENTERLINES AND TO WALL FINISH.	2. INSTALL OUTLETS PE	ALL IN WOOD FRAMING. R NEC & BUILDING CODE FINAL MILLWORK & OWNER.	3. INSULATION FOR UNCONDITIONED GA         A. <u>ROOF:</u> R-30         B. <u>WALLS:</u> WOOD STUD: R-13	1KAGE
<ol> <li>U.O.N, CONFIRM EXACT LOCATIONS OF SCONCE PICTURE LIGHTS, &amp; FLOOR RECEPTACLES W OWNER.</li> </ol>	ITH 3. AT CABINETS & TILE CUT-IN BOX INSTAL	RUN WIRES LONG FOR GEM/ LATION. FINAL LOCATION TO		
<ol> <li>EXTERIOR LIGHTS: COORDINATE LANDSCAPE LIGHTIN FLOOD LIGHT LOCATIONS WITH OWNER.</li> <li>COORDINATE APPLIANCE WITH OWNER.</li> </ol>	4. PLUG MOLD: INSTA	FIELD. LL FACE DOWN AT BACK OF CABINETS. VERIFY W/ OWNER.	4. ALL NEW POWER, LIGHTING, & MECH BE COORDINATED BY OWNER WITH C	
6. SWITCHES: U.O.N., LOCATE SWITCHES @ 48" A AND 7" (10" MAX) FROM FINISH JAMB TO CENTER	RLINE		5. WHERE MODIFYING WALLS OR CEILING CONDITIONED SPACE THAT MAY COMP	PROMISE EXISTING INSU
OF SWITCH (FIRST GANG IF MULTI-GANG). 7. SWITCHES AT TILE & CABINETRY: RUN WIRES LONG FOR CUT-IN BOX INSTALLATION. FINAL	DO DOOR OPENER	NOTATIONS	REPAIR/REPLACE WITH CODE MINIMUN	
LOCATIONS TO BE DETERMINED IN FIELD. 8. EXTERIOR IN-USE BOXES SHALL BE RECESSED			AND EVALUATE FURTHER STRUCTURAL	REVIEW PRIOR TO CON
<ol> <li>ALL EXTERIOR LIGHTING SHALL BE CUT-OFF T &amp; SHALL CONFORM W/ BUILDING CODES.</li> <li>INSTALL NEW 'WARMFLOOR - STEP' ELECTRIC</li> </ol>			8. NEW CONCRETE GARAGE FLOOR TO H	
FLOOR HEATING SYSTEM (OR EQUAL) AT MASTE TILE FLOOR LOCATIONS, EXCEPT SHOWER; INST	ER BATH    ALL		9. NEW STUD WALLS TO BE 2X4 @ 16"	
PER MANUFACTURER RECOMMENDATION; CONTR TO VERIFY ELECTRICAL REQ'S & COORDINATE I	NSTALL.		10. COORDINATE FINAL CEILING FRAM LOCATIONS TO AVOID CONFLICT.	MING W/ ELECTRICAL T.B.D.
CONTRACTOR TO VERIFY EXISTING SWITCHING IN FILD AND COORDINATE FINAL LOCATION WITH OWNER		4'-0' 7'-6"	DIDIR HEADER PER SCHEDULE VINDOW HEADER PER SCHEDULE VINDOW HEADER PER SCHEDULE	
EQUAL 6 PROPOSED ELEVATION	EQUAL	COORDINATE SWITCHIN REQUIREMENTS FOR N FLOOD LIGHT WITH O		
A101 SCALE: 1/46" = 1'-0"			A101 SCALE: 1/46" = 1'-0"	

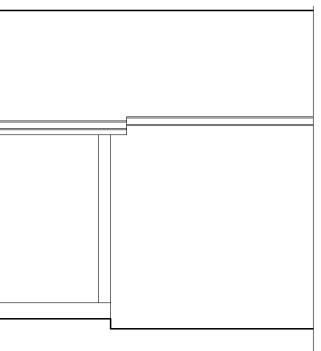


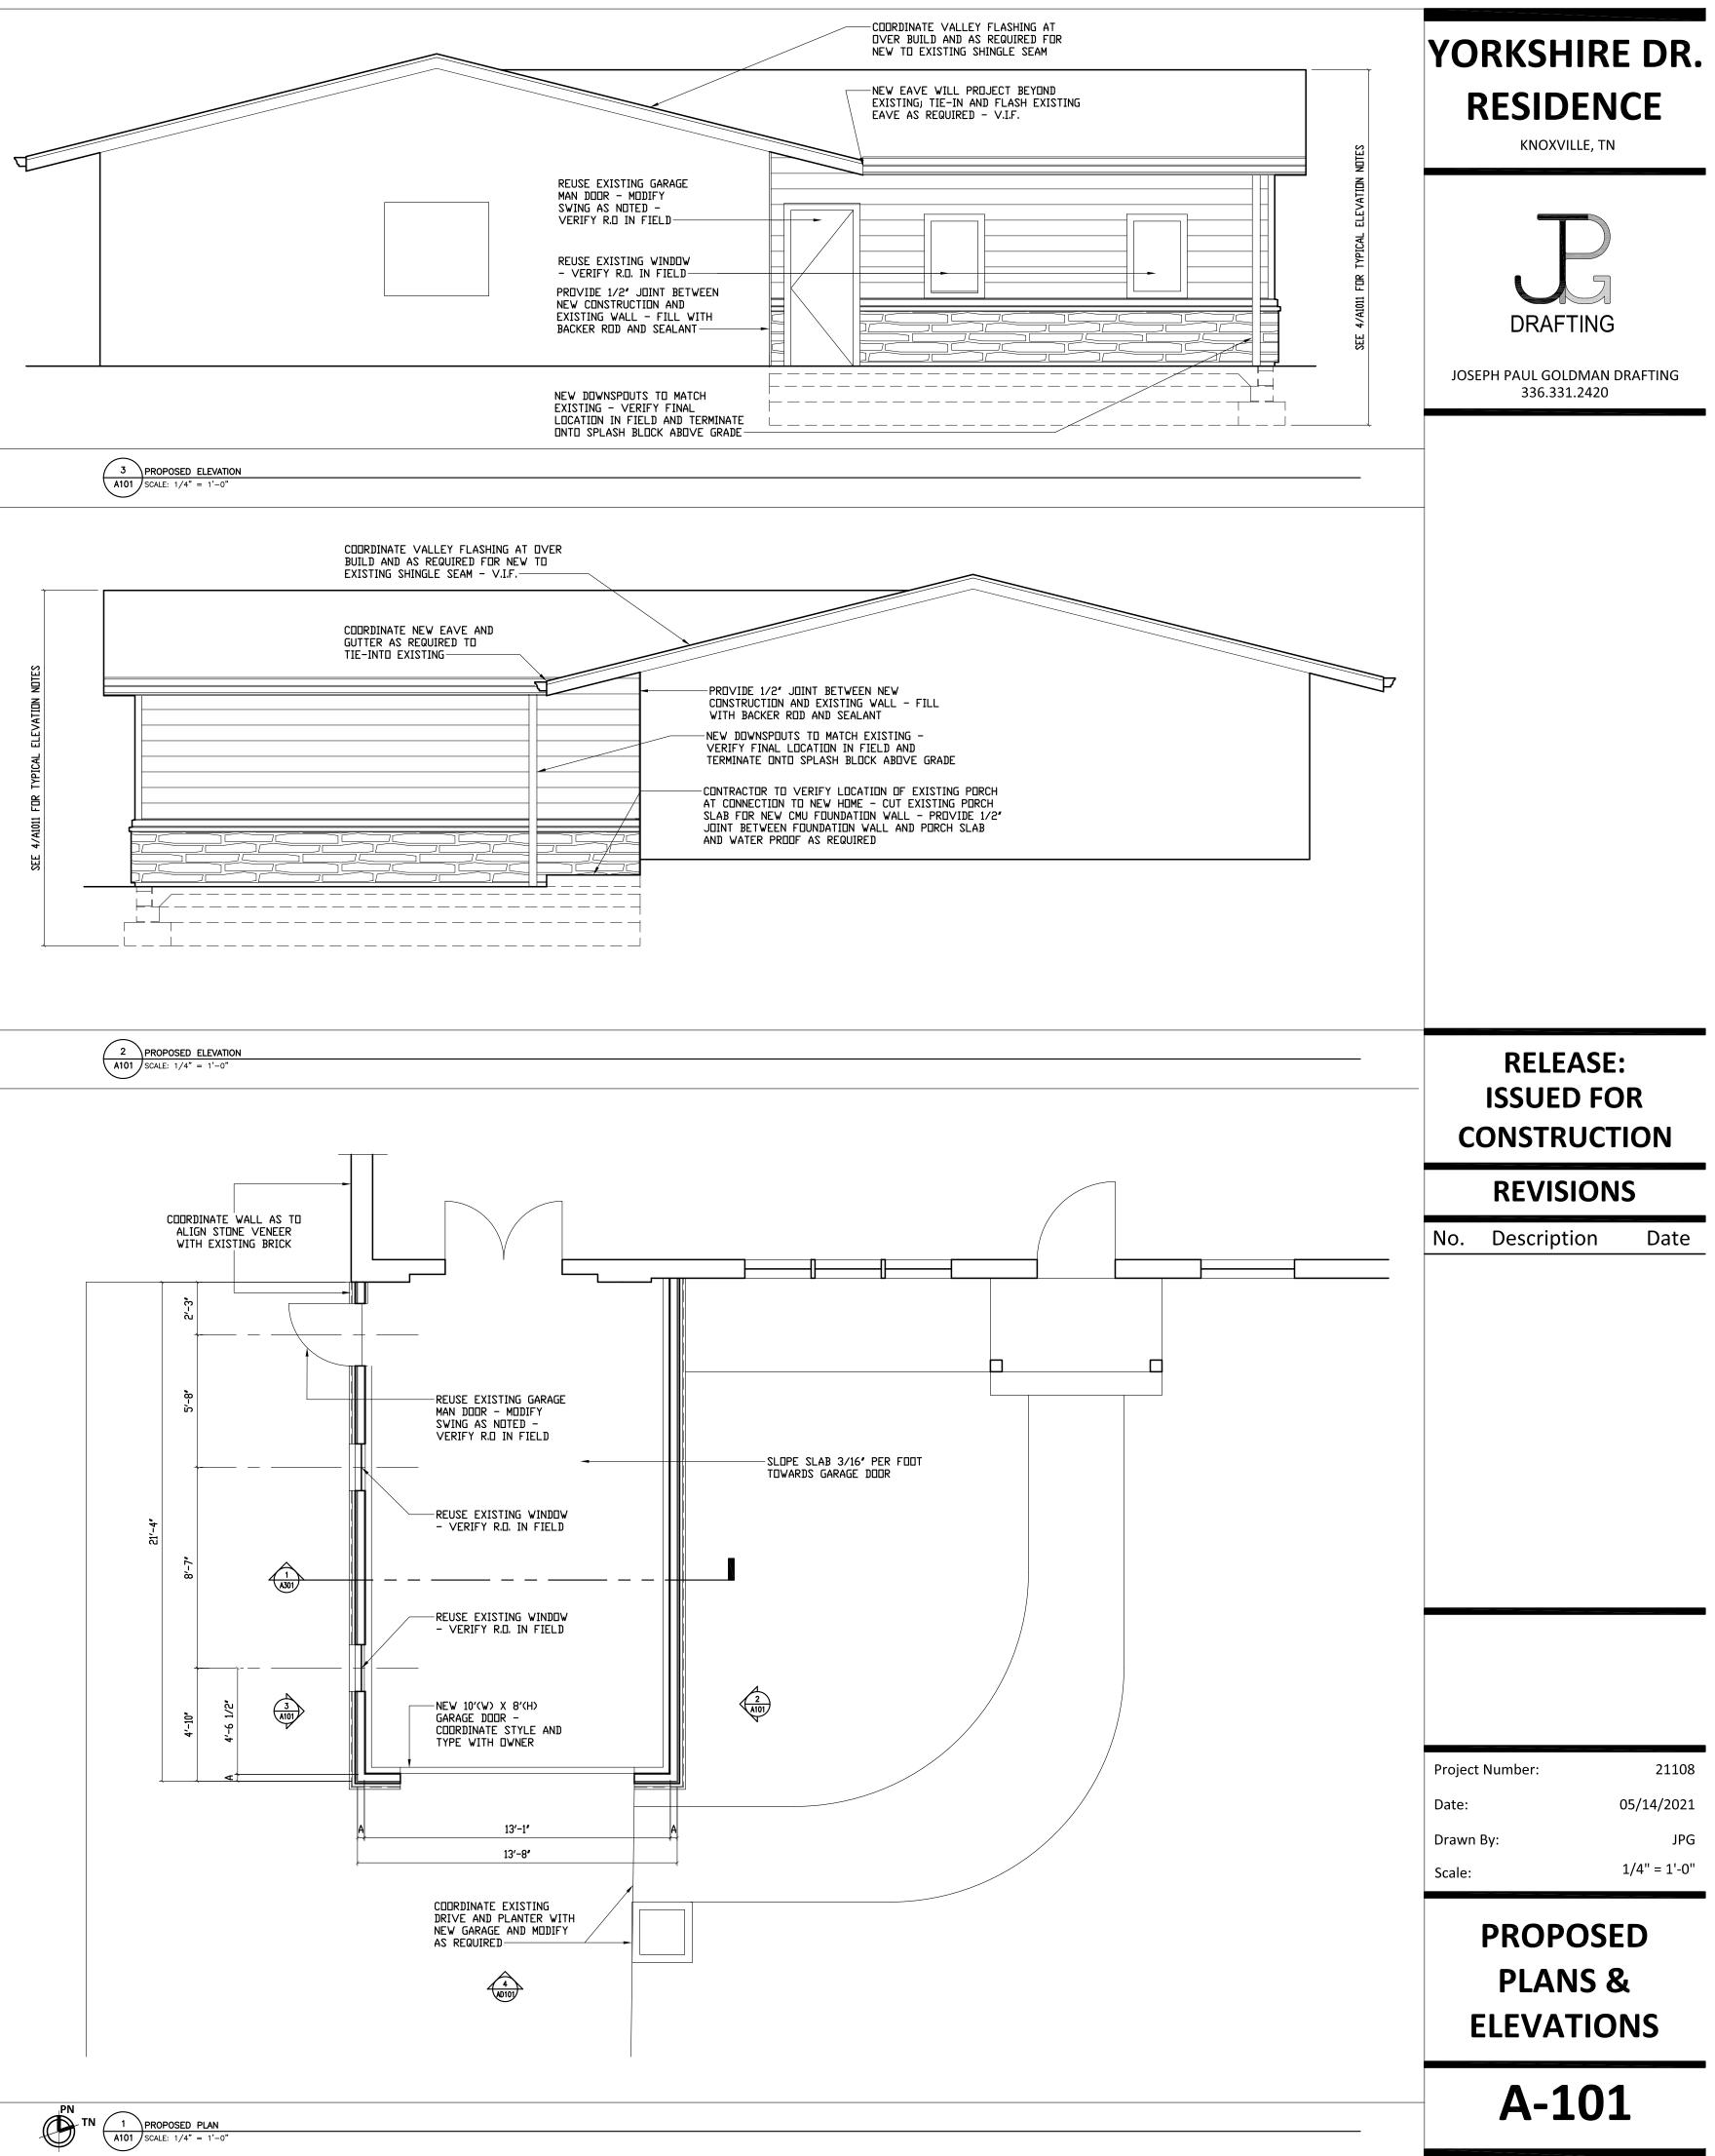


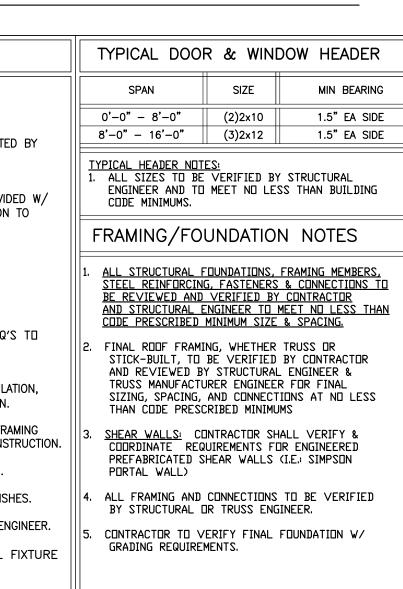


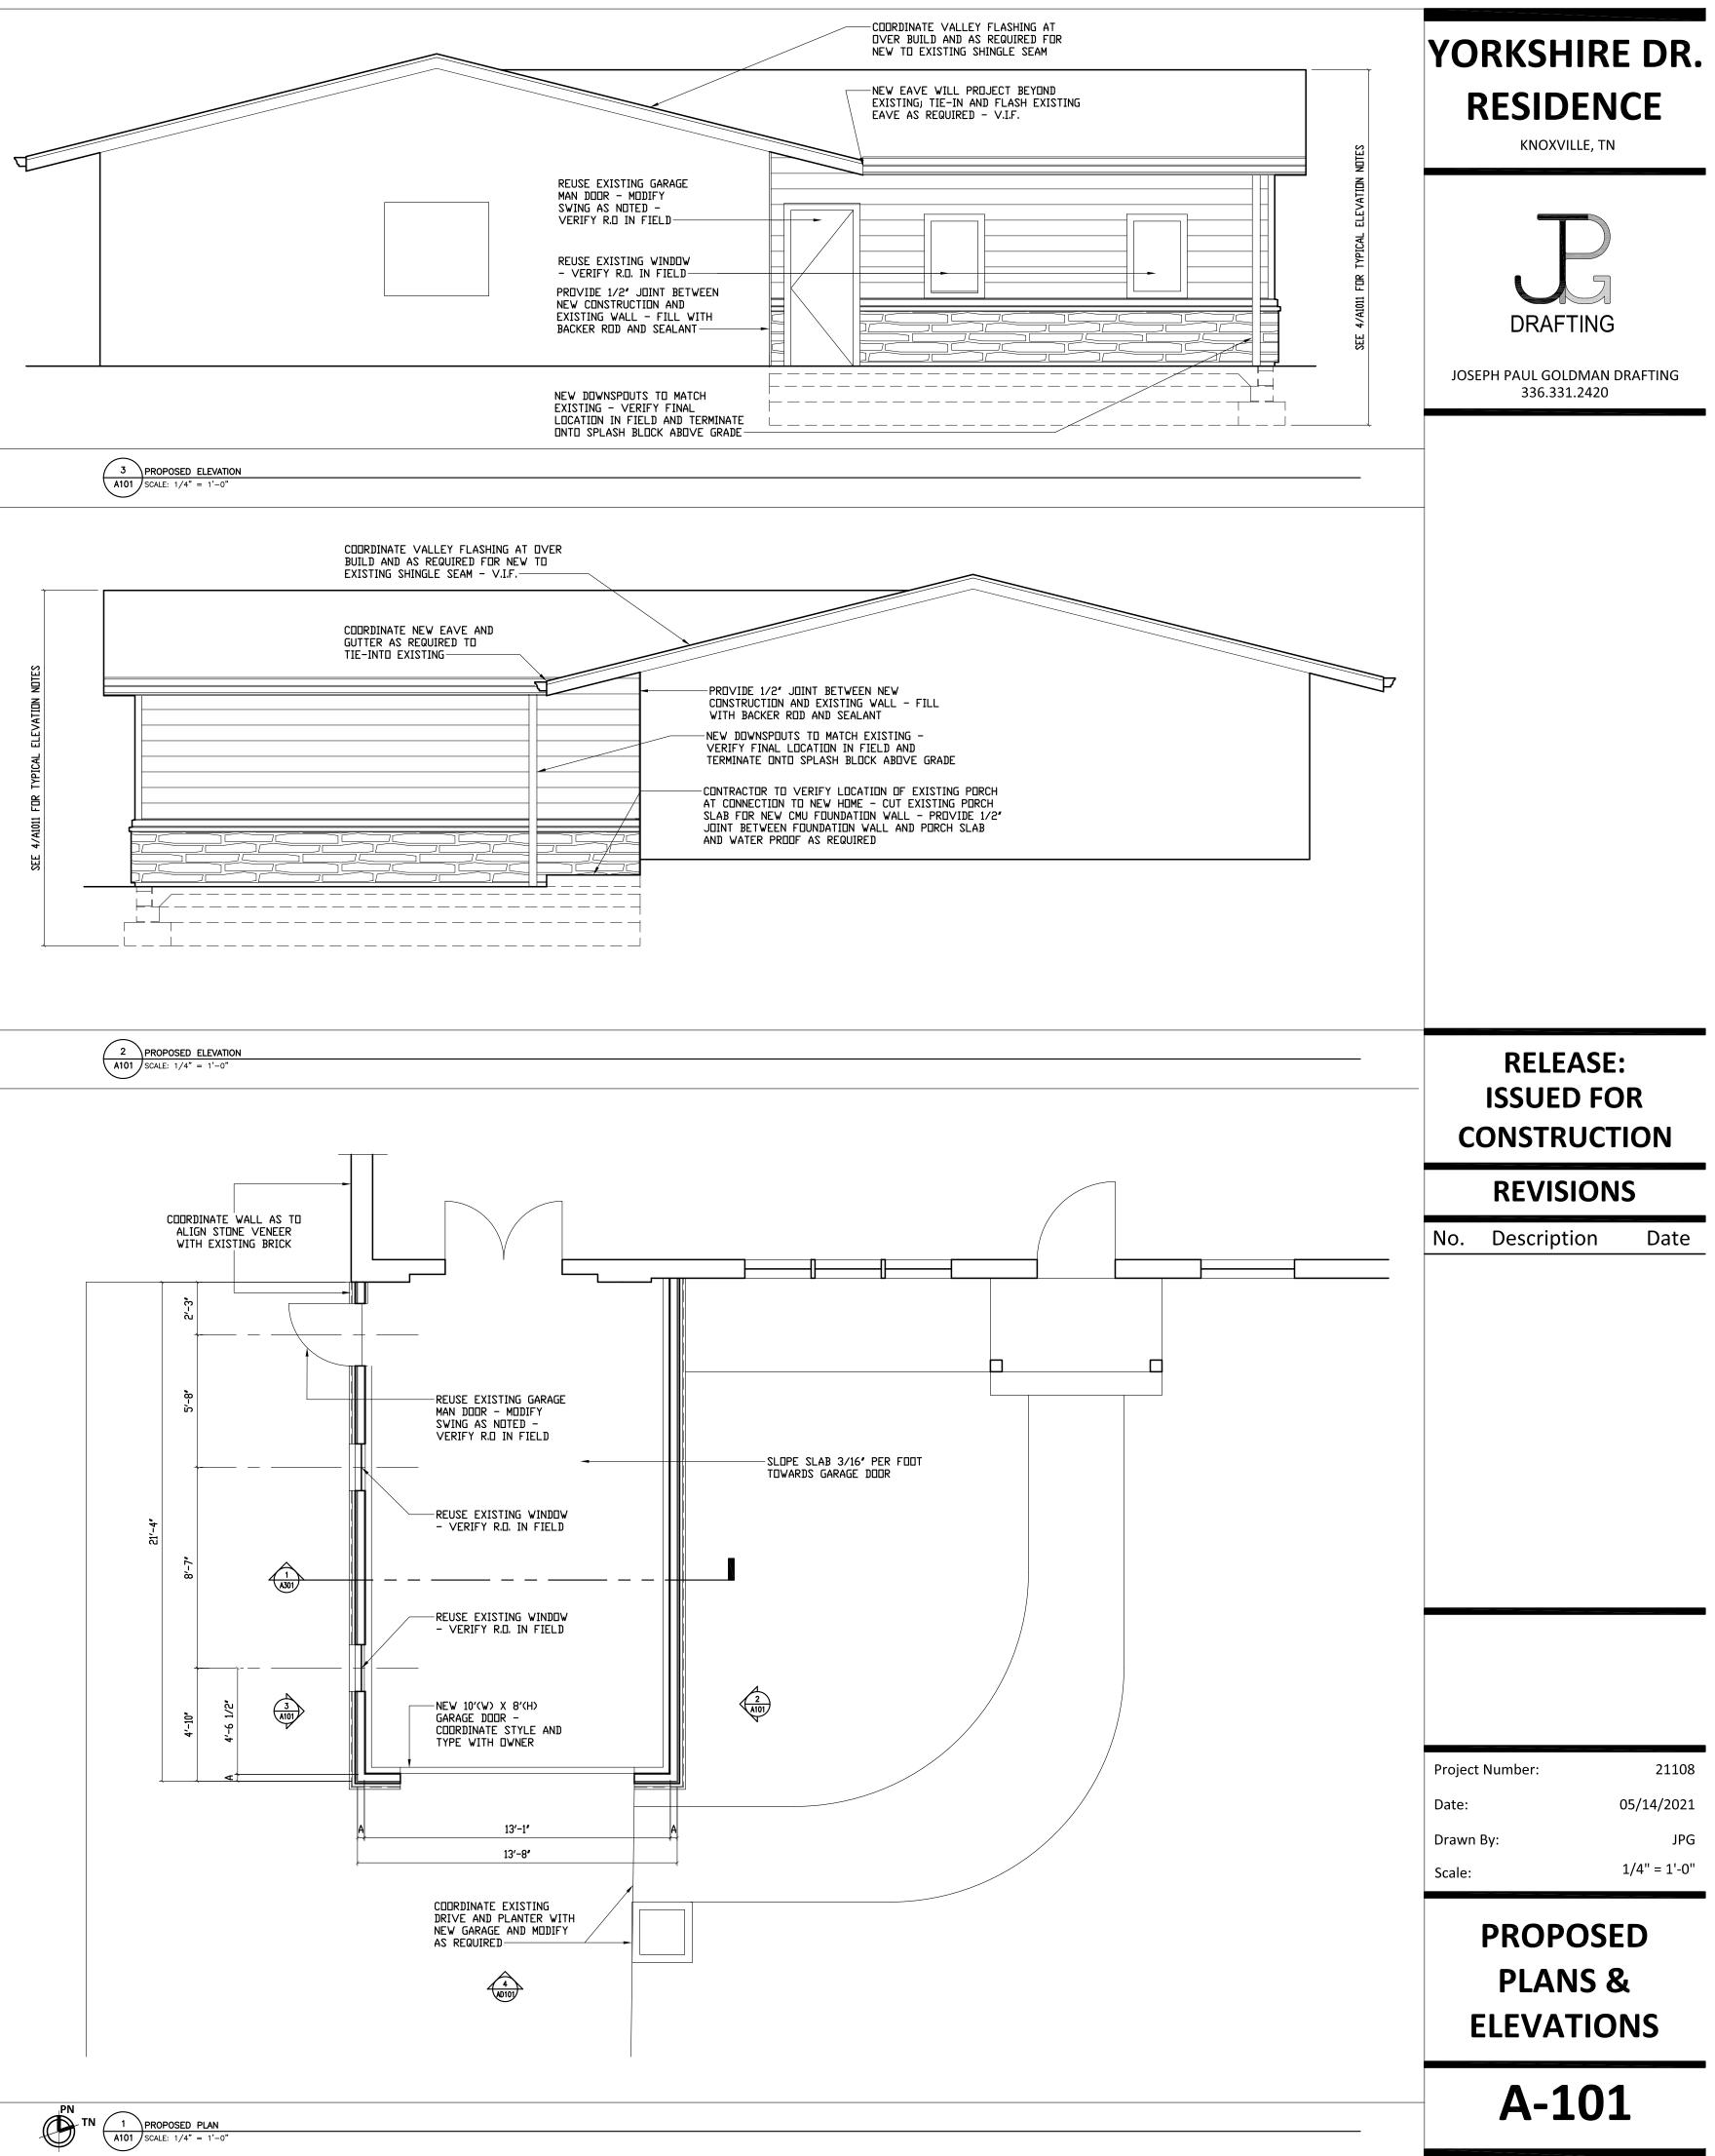





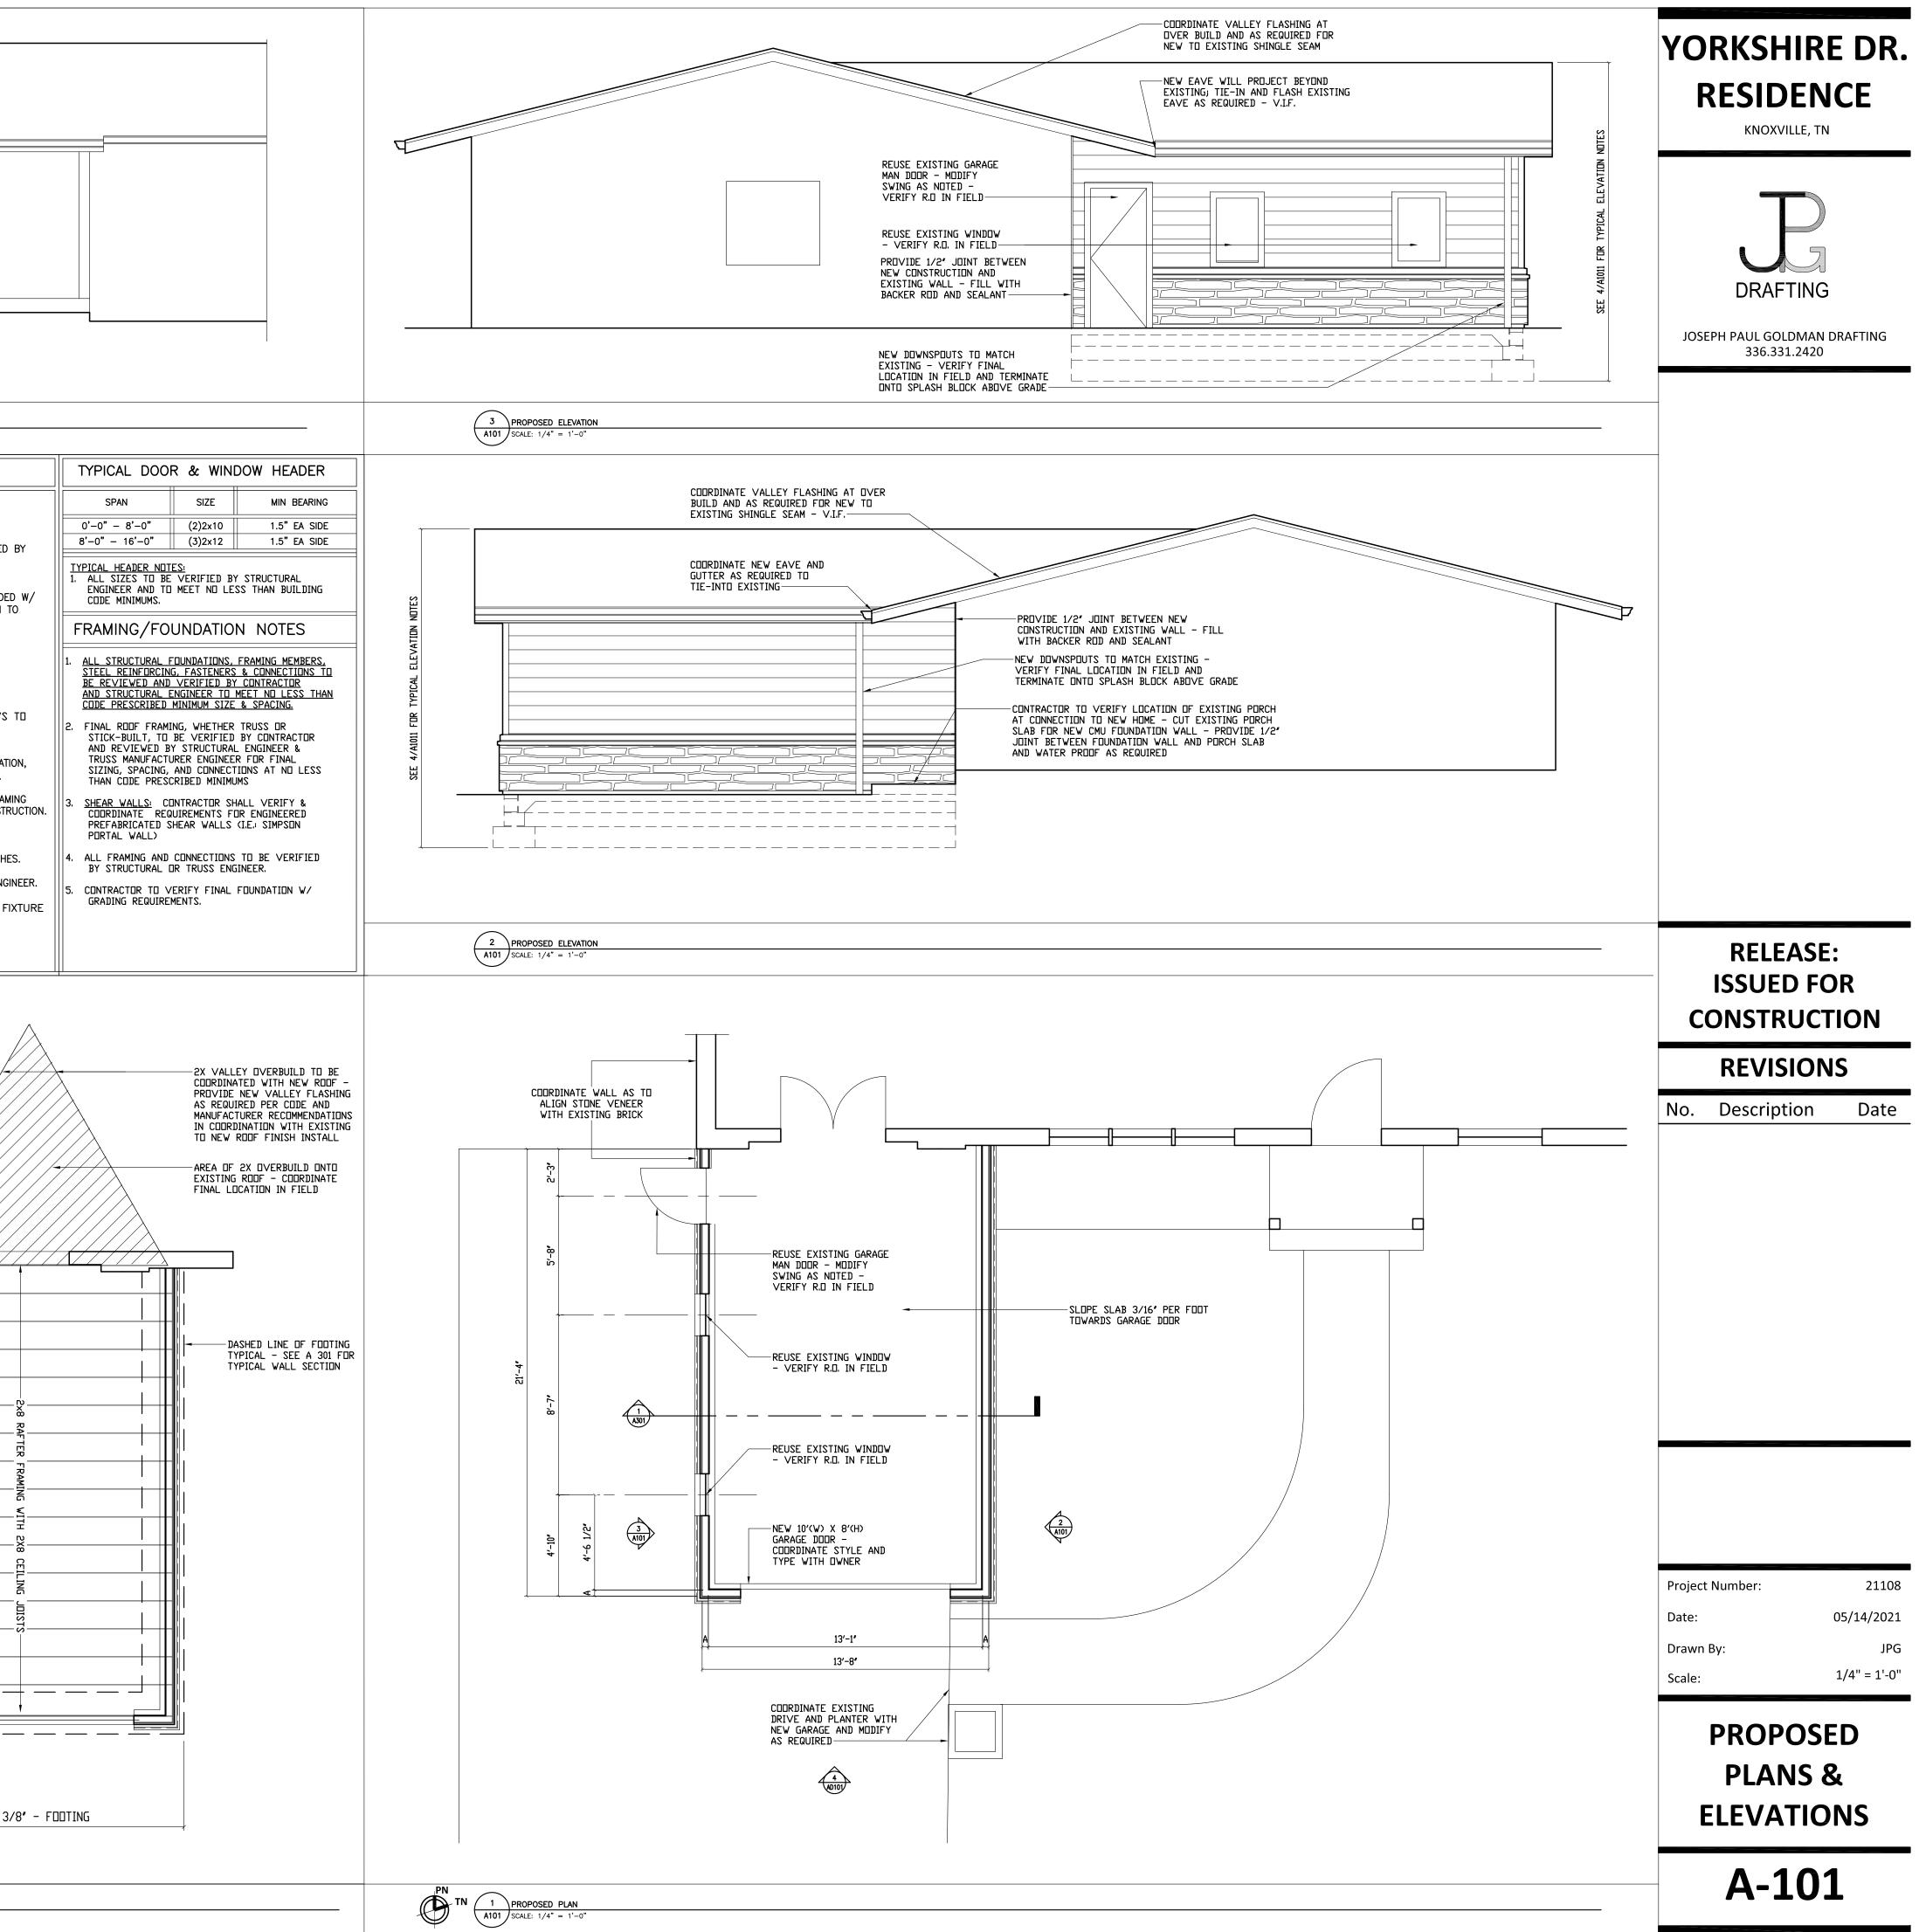

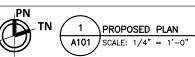

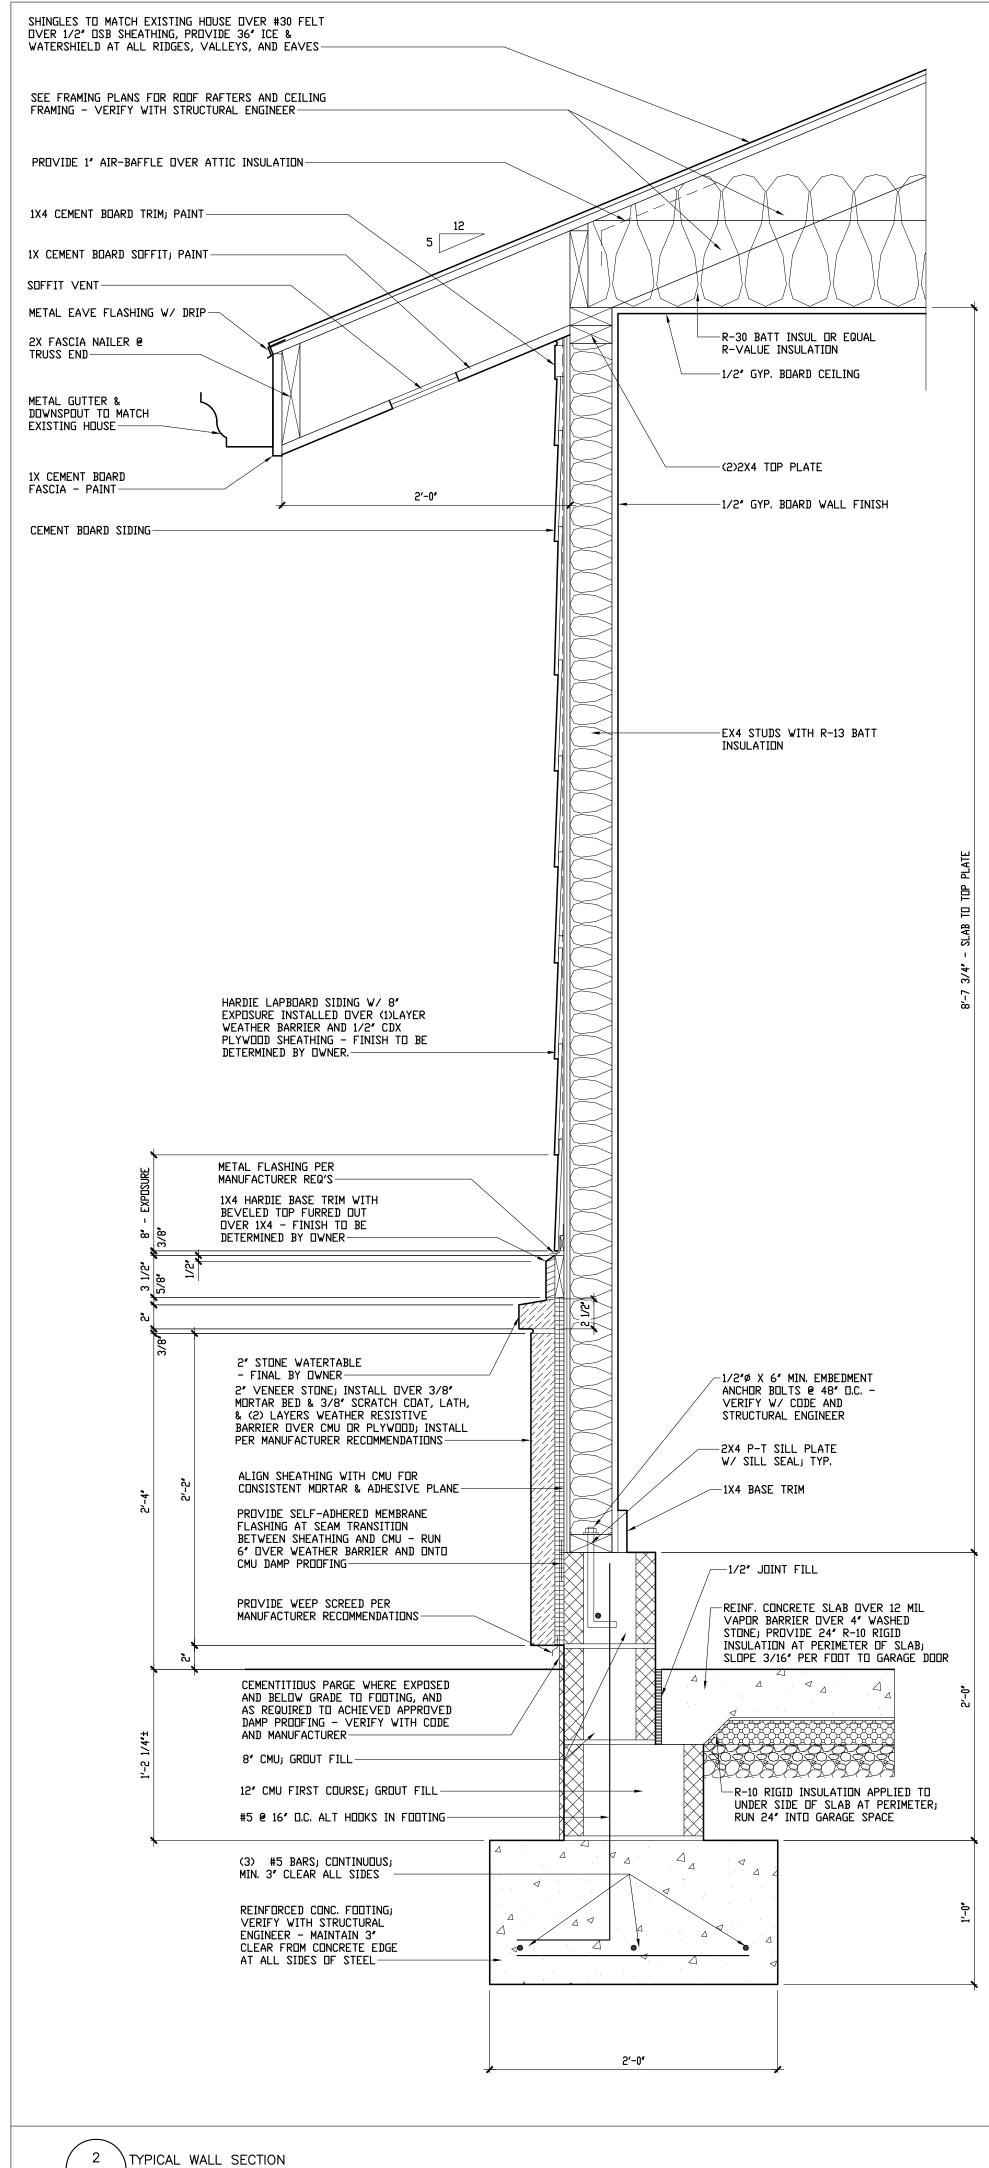

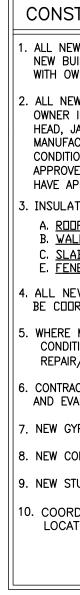

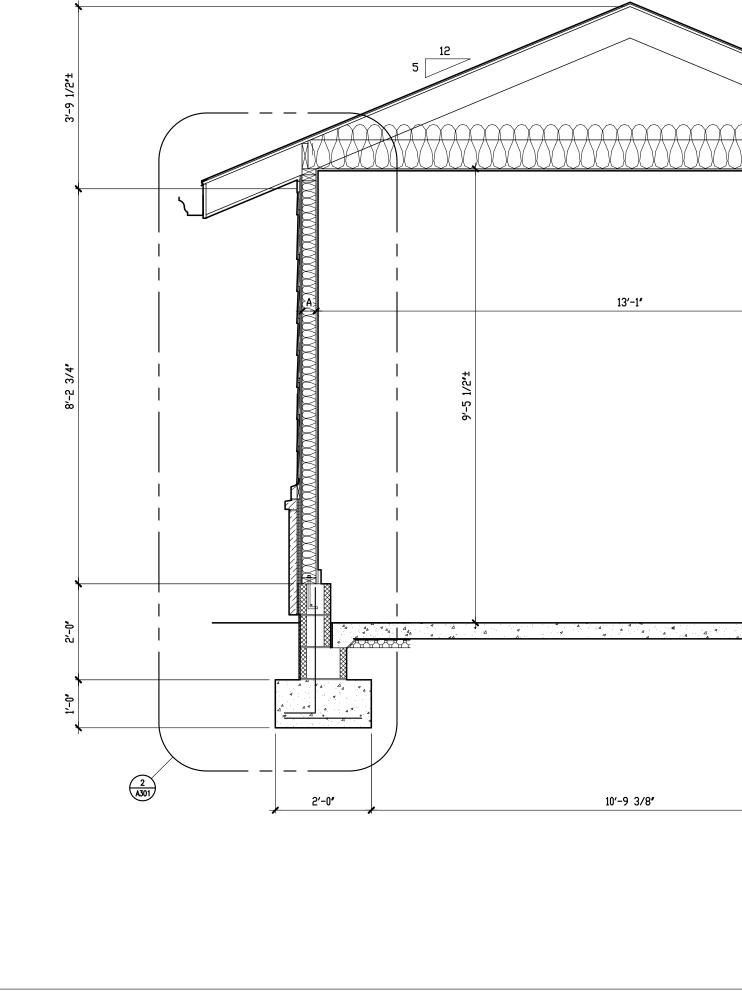


1 TYPICAL GARAGE CROSS SECTION (A-301) SCALE: 1/2" = 1'-0"

\*

STRUCTION GENERAL NOTES:	TYPICAL DOO	R & WINI	DOW HEADER		
NEW INTERIOR FINISHES REQUIRED TO BE MODIFIED BY BUILD-OUT TO MATCH EXISTING - COORDINATE FINAL	SPAN	SIZE	MIN BEARING	YORKSH	IRE DR.
OWNER. NEW EXTERIOR DOOR SLABS & WINDOWS TO BE SELECTED BY	0'-0" - 8'-0" 8'-0" - 16'-0"	(2)2x10 (3)2x12	1.5" EA SIDE 1.5" EA SIDE	RESID	ENCE
R IN COORDINATION W/ CONTRACTOR. INSTALL NEW , JAMB, AND SILL FLASHING PER CURRENT CODE & FACTURER RECOMMENDATIONS. ALL DOORS SEPARATING ITIONED FROM UNCONDITIONED SPACES SHALL BE PROVIDED W/		: VERIFIED BY	' STRUCTURAL SS THAN BUILDING	KNOXVIL	LE, TN
OVED WEATHER SEALS & GASKETING; EXTERIOR LOCATION TO APPROVED THRESHOLDS AND \ RAIN GUARD.	FRAMING/FO	UNDATIO	N NOTES		
LATION FOR UNCONDITIONED GARAGE <u>DDF:</u> R-30 <u>(ALLS: </u> WODD STUD: R-13	1. ALL STRUCTURAL I	FOUNDATIONS,		1 1	$\Box$
L <u>AB EDGE</u> : R-10 TO 2'-0" HORIZONTAL <u>ENESTRATION:</u> SEE SHEET A001	BE REVIEWED AND	VERIFIED BY	<u>CONTRACTOR</u> MEET NO LESS THAN		5
NEW POWER, LIGHTING, & MECHANICAL SYSTEMS REQ'S TO DORDINATED BY OWNER WITH CONTRACTOR. RE MODIFYING WALLS OR CEILINGS ENCLOSING EXISTING	2. FINAL ROOF FRAM STICK-BUILT, TO AND REVIEWED B	BE VERIFIED	BY CONTRACTOR	DRAFT	ING
DITIONED SPACE THAT MAY COMPROMISE EXISTING INSULATION, AIR/REPLACE WITH CODE MINIMUM REQUIRED INSULATION.	TRUSS MANUFACT	URER ENGINEE AND CONNECT	R FOR FINAL IONS AT NO LESS	JOSEPH PAUL GOLD	
RACTOR TO VERIFY CONDITION OF EXISTING BUILDING FRAMING EVALUATE FURTHER STRUCTURAL REVIEW PRIOR TO CONSTRUCTION.	3. <u>SHEAR WALLS:</u> CI COORDINATE REG PREFABRICATED S	QUIREMENTS FO	JR ENGINEERED	336.331.	2420
GYP. BOARD TO BE 1/2" W/ FINISH T.B.D. BY OWNER. CONCRETE GARAGE FLOOR TO HAVE HARD TROWEL FINISHES.	PORTAL WALL> 4. ALL FRAMING AND BY STRUCTURAL I	CONNECTIONS OR TRUSS ENG	TD BE ∨ERIFIED INEER.		
STUD WALLS TO BE 2X4 @ 16" O.C. – VERIFY WITH ENGINEER.	5. CONTRACTOR TO V GRADING REQUIRE	ERIFY FINAL			
CATIONS TO AVOID CONFLICT. T.B.D.					
				RELEA	ASE:
				ISSUED	
				CONSTRU	JCTION
				REVISI	ONS
				No. Descripti	on Date
				Project Number:	21108
				Project Number: Date:	21108 05/14/2021
				Date: Drawn By:	05/14/2021 JPG
				Date:	05/14/2021
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A-301

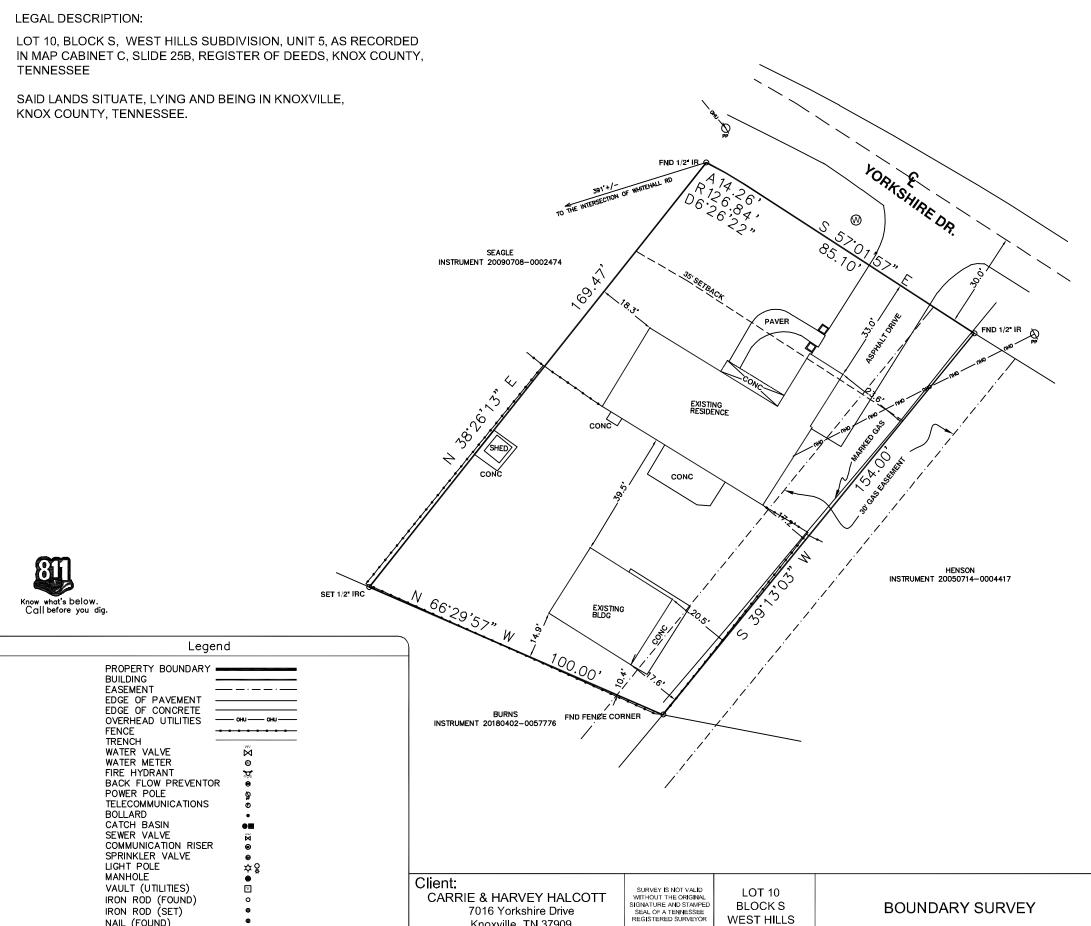

**CARRIE & HARVEY HALCOTT** 

7016 Yorkshire Drive

Knoxville, TN 37909

LOT 10

BLOCK S

WEST HILLS

V

0

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IRON ROD (SET)


NAIL (FOUND)

NAIL (SET)

2) 3) 5) 6) 7)

1)

BOUNDARY SURVEY

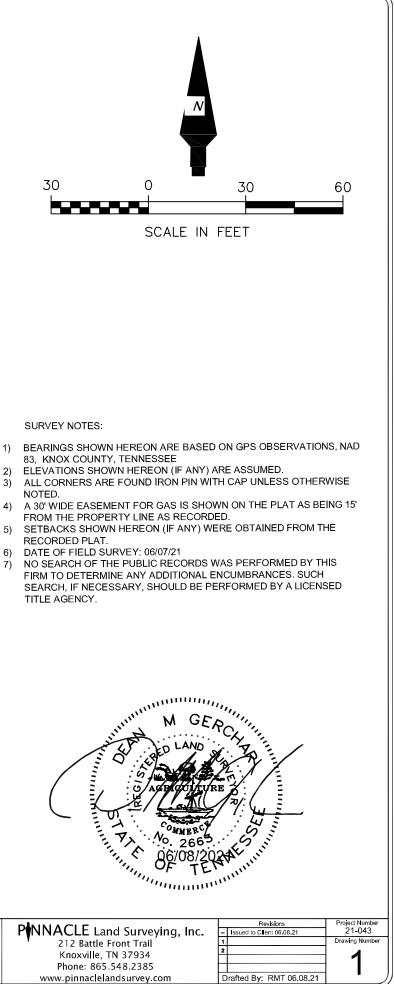

July 9, 2021

Mr. Scott Elder Board of Zoning Appeals Room 475, City-County Building P. O. Box 1631 Knoxville, Tennessee 37901

Dear Mr. Elder:

## Re: Variance Requests 7-A-21-VA and 7-B-21-VA

We have reviewed our records and, as far as we have been able to determine, KUB has no existing utility facilities located within the variance areas and we have no objection to the requested variances. However, KUB does not release and hereby retains all easements and rights for existing facilities, whether or not identified in our research.

If you have any questions regarding this matter, please call me at (865) 558-2483.

Sincerely,

blit WK

Christian Wiberley, P.E. Engineering

CGW

Electricity · Gas · Water · Wastewater

## **RE: BZA July applications**

Steve Borden <Steve.Borden@tn.gov>

Mon 7/12/2021 4:03 PM

To: Cheri Burke <cmburke@knoxvilletn.gov>

Please find the following responses from TDOT District 18 Operations for the July BZA applications:

7-A-21-VA: 1315 Chilhowee Avenue – Operations has no comment. 7-B-21-VA: 7016 Yorkshire Drive – Operations has no comment.



Steven M. Borden, P.E. | Director/Assistant Chief Engineer

TDOT – Region 1 7345 Region Lane Knoxville, TN 37914 (865) 594-2400 <u>Steve.Borden@tn.gov</u> <u>tn.gov/tdot</u>

From: Cheri Burke <cmburke@knoxvilletn.gov> Sent: Tuesday, July 6, 2021 9:20 AM To: Steve Borden <Steve.Borden@tn.gov> Subject: [EXTERNAL] BZA July applications

\*\*\* This is an EXTERNAL email. Please exercise caution. DO NOT open attachments or click links from unknown senders or unexpected email - STS-Security. \*\*\*

Good morning Steve,

Please have your staff review the applications located at this link and provide your response by 7/12/21.

7-A-21-VA: 1315 Chilhowee Avenue 7-B-21-VA: 7016 Yorkshire Drive

Thank you,

Cheri Burke

Administrative Specialist

Neighborhood Codes Enforcement

City of Knoxville